

Transmittal Page 1 of 2

To: Planning Department City of Kelowna

CC: Dave Dhaliwal davedhaliwal00@gmail.com

March 15, 2023

Re: Design Rationale for the Proposed Development of

1010 Martin Avenue, Kelowna, BC (The Site)

Dear City of Kelowna Planning Department,

Further to submitted information as it pertains to the Development Permit application associated with the proposed Development of 1010 Martin Avenue in Kelowna, we offer the following Design Rationale for the project:

Located on the corner of Graham Street and Martin Avenue, Martin Avenue is located between the Downtown and Bankhead area of Kelowna. The project location is in close proximity to the Downtown Core which includes shopping, personal services, and restaurants allowing most errands from the location to be accomplished by foot. This property boasts a Bike Score of 94 and a Walk Score of 66, making the downtown core and surrounding community easily accessible. Kelowna's Downtown area is ideally located for multi-unit residential use as the area is experiencing tremendous population growth with low market availability. Because of its associated high walk score and bike score, the reliance on automobile use is greatly reduced allowing the area to diversify while creating healthy community practices and reducing the residents carbon footprint.

The building design includes 4 easily accessible units with all entries on ground level and attached garages for each residence. The central location of the property influenced an overall design that includes the provision of additional non-required bicycle parking. The reduction in automobile reliance in conjunction with the higher density infill development of the property contribute to a more sustainable approach to the building design that aligns with the City of Kelowna's Healthy City Strategy and planning initiatives. The design concept for the building includes providing the required private outdoor space in the form of rooftop decks for each of the 4 residences.

The priority to densify precious, developable land within an existing urban centre while ensuring the neighbouring properties were respected resulted in a building that is under the 8m height requirement set out by the MF1 zoning. Achieving 4 residences on the property while being sensitive to the neighbourhood was felt to be important from a location and sustainability standpoint. The result is an attractive infill project that provides needed residential units, addresses the human scale while being sensitively designed to reduce impact on neighbouring properties.

The proposed variance is to accommodate for the detached garage which is 2.0m from the flanking street instead of the required 4.0m.

In summary, the rationale for this project is as follows:

- i. Provide a thoughtful, sustainable infill housing solution to a property located near the urban centre of Kelowna.
- ii. Provide 4 residences that provide generous private outdoor amenity spaces for each unit.



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- iii. The proposed development meets the City of Kelowna Parking Bylaw requirements. Specifically, and in conjunction with zoning requirements, the project provides the required vehicle parking space for all 4 residences (4 stalls)
- iv. The proposed development results in a building design that is attractive in its design, is inviting and addresses the human scale at ground level as well is sensitive to the neighbourhood at large by the way it has been designed and massed on the site.
- v. The proposed development provides the required 3 bicycle storge spaces and as well accommodates for an additional 5 non-required bicycle storage spaces, 4 being inside the detached garage.

This proposed development recognizes the City of Kelowna's strategic approach to overall residential growth including better use of precious developable land in accordance with the City's OCP/Future Land Use, Healthy City Strategy, and planning initiatives.

We look forward to your supportive comments in response to this Development Permit application and kindly ask that you do not hesitate to contact our office if you have any questions or require additional information in these matters.

Sincerely:

Matt Johnston

Architect AIBC, LEED AP

LIME Architecture Inc.

LOT 1 MARTIN AVE, KELOWNA BC

PROPERTY DESCRIPTION

CIVIC: 1010 MARTIN AVE, KELOWNA BC LEGAL: LOT 1, PLAN KAP6806

BC ENERGY STEP CODE COMPLIANCE: STEP 3


ZONING CALCULATIONS:

CURRENT: CITY OF KELOWNA MF1 ZONING

SITE INFORMATION:



	(0.51.05 (501.0) ()	ALLOWED	PROPOSED	
ALLOWABLE SITE COV	6,251 SF (581 SM) 'ERAGE= 'ERAGE & HARDSCAPING=	55% (3,438.1 SF) 75% (4,688.3 SF) .8 (5,000.8 SF)	53% (3,303 SF) 72% (4,527 SF) .74 (4,648 SF)	
UNIT AREA CALCULAT	IONS:			
UNIT 1 ENTRY: UPPER:	599 SF 561 SF			
UNIT 2 ENTRY:	600 SF			
UPPER:	569 SF			
UNIT 3 ENTRY:	600 SF			
UPPER:	569 SF			
UNIT 4 ENTRY:	589 SF			
UPPER:	561 SF			
TOTAL:	4,648 SF			
		ALLOWED	PROPOSED	
HEIGHT=		8.0M (2 STOREYS)	7.2M (2 STOREYS)	
YARD SETBACKS:				
FRONT YARD=		4.0M	4.0M	
FLANKING STREET=		4.0M	2.0/4.0M -\	/ARIANCE
SIDE YARD=		1.2M	1.2M	REQUIRED
REAR YARD=		0.9M	0.9M	
PARKING CALCULATION	DNS:			
LESS THAN 5 DWELLIN		1/DWELLING UNIT	4	
LONG-TERM BICYCLE	<u>STORAGE</u>			ii.
TOWNHOMES WITH F	PRIVATE GARAGE =	4	4	I STRE
SHORT-TERM BICYCLE	E STORAGE			graham street
LESS THAN 5 DWELLIN	IG UNITS =	0	0	S

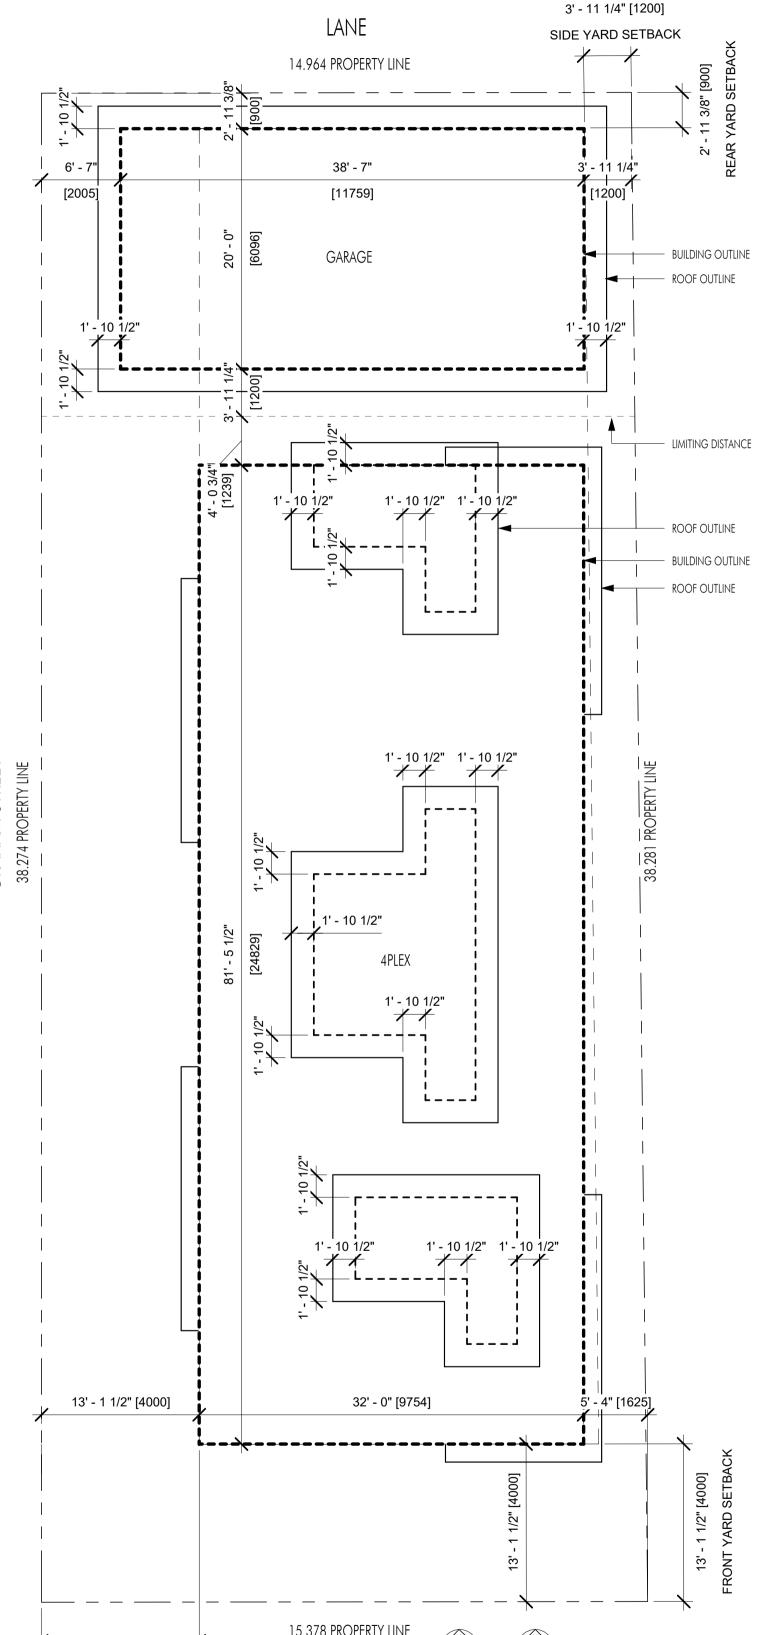

GENERAL NOTES - ARCHITECTURAL:

ALL WORK SHALL CONFORM TO THE STANDARDS OF THE N.B.C. OF CANADA 2015 (ALL APPLICABLE SECTIONS), THE B.C. BUILDING CODE (BCBC) 2018 AND ALL LOCAL CODES, BYLAWS AND AMENDMENTS.

-DO NOT SCALE DRAWINGS; DIMENSIONS ALWAYS TAKE PRECEDENCE.

-ALL TRADES SHALL VERIFY ALL DATUM'S, DIMENSIONS AND LEVELS PRIOR TO COMMENCEMENT OF WORK.

-ALL ERRORS AND OMISSIONS TO BE REPORTED IMMEDIATELY TO LIME ARCHITECTURE.

-VARIATIONS AND MODIFICATIONS TO THE WORK SHOWN ON DRAWINGS SHALL NOT BE CARRIED OUT WITHOUT THE EXPRESS WRITTEN PERMISSION OF LIME

-THESE DRAWINGS ARE THE EXCLUSIVE PROPERTY OF LIME ARCHITECTURE AND CANNOT BE REPRODUCED WITHOUT THE EXPRESSED WRITTEN PERMISSION OF LIME ARCHITECTURE.

-ALL WORK TO BE PERFORMED TO CURRENT GOOD TRADE PRACTICE STANDARDS BY WORKMEN SKILLED IN THEIR TRADES.

-ALL MATERIALS TO BE OF GOOD QUALITY, PROPERLY TRANSPORTED, STORED AND PROTECTED.

-ALL EXTERIOR DIMENSIONS TAKEN FROM OUTSIDE FACE OF WOOD STUDS AND EXTERIOR FACE OF CONCRETE UNLESS NOTED OTHERWISE.

-ALL INTERIOR DIMENSIONS TAKEN FROM CENTER LINE OF STUDS U.N.O.

-ALL LOAD BEARING LUMBER TO BE SPF #2 OR BETTER U.N.O. -ALL LOAD BEARING WOOD BEAMS TO BE SPF #2 OR BETTER U.N.O.

-ALL EXTERIOR WALLS TO BE 2 X 6 @ 24" O.C., U.N.O.

-INTERIOR WALLS TO BE 2 X 4 @ 24" O.C., U.N.O.; INTERIOR LOAD BEARING WALLS TO BE 2X6 @ 16" O.C., U.N.O. (SHOWN SHADED ON PLAN DRAWINGS)

-USE DOUBLE JOISTS UNDER PARTITIONS PARALLEL TO JOISTS UNLESS NOTED OTHERWISE (U.N.O.).

-ALL LOAD BEARING COLUMNS TO BE AT LEAST EQUAL TO WIDTH OF BEAMS AND OF SOLID LUMBER OR LAMINATED STUDS.

-LINTELS UP TO 6'-0" WIDE TO BE 2-2 X 10 SPF #2 OR BETTER U.N.O. - TO BE BUILT UP TO EQUAL WIDTH OF WALL FRAMING. -LINTELS OVER 6'-0" TO BE 2-2 X 12 SPF #1 OR BETTER OR ENGINEERED UNLESS NOTED OTHERWISE (U.N.O.).

-FRAMING TRADE TO PROVIDE MIN. 2 X 2 CROSS BRACING OR SOLID BLOCKING BETWEEN JOISTS AND RAFTERS @ 7'-0" O.C. MAXIMUM, MINIMUM ONE ROW UNLESS

NOTED OTHERWISE BY FLOORING ENGINEER. -ALL FOOTINGS TO BEAR ON UNDISTURBED NATIVE SOIL, APPROVED ENGINEERED FILL OR BEDROCK AND EXTEND A MINIMUM DEPTH 300MM BELOW FROST LINE

FROM FINISHED GRADE

-MINIMUM CONCRETE STRENGTH AT 28 DAYS: FOOTINGS, SLABS, FOUNDATION WALLS: 3000PSI, LIGHTWEIGHT CONCRETE TOPPING: 4000PSI. -MINIMUM PAD FOOTING SIZES AS PER STRUCTURAL NOTES BELOW AND/OR AS NOTED ON PLAN DRAWINGS (LARGEST PAD AND REINFORCING SIZES TO TAKE

PRECEDENCE WHERE CONTRADICTION EXISTS).

-SECURE SILL PLATES TO FOUNDATION WALLS WITH 1/2" DIAM. X 10" ANCHOR BOLT @ 4'-0" O.C. FOR EXTERIOR WALLS AND 6'-0" FOR INTERIOR WALLS. -ALL WOOD MEMBERS IN CONTACT WITH CONCRETE TO BE PROTECTED WITH SILL PLATE GASKET.

-PROVIDE DAMPROOFING TO ALL EXTERIOR FOUNDATION WALLS (INCLUDING RE-DAMPROOFING) IN ACCORDANCE WITH BCBC 2018.

-PROVIDE A MINIMUM OF 6" CLEARANCE BETWEEN SOIL AND ANY WOOD MEMBERS.

-ALLOWABLE SOIL BEARING PRESSURE 2000 PSF ASSUMED FOR DESIGN AND TO BE CONFIRMED AT EXCAVATION BY A QUALIFIED ENGINEER.

-PROVIDE ALUMINUM FLASHINGS OVER ALL EXTERIOR OPENINGS.

-CAULK AND SEAL ALL EXTERIOR OPENINGS IN ACCORDANCE WITH BCBC 2018. -VENTILATION REQUIREMENTS TO CONFORM TO BCBC 9.32.3 AND TABLE 9.32.3.5.

-UNIFORMLY DISTRIBUTE VENTILATION TO ROOFS AS PER BCBC 9.19.1.2.

-PROVIDE A MINIMUM CLEARANCE BETWEEN TOP OF ROOF INSULATION AND UNDERSIDE OF ROOF SHEATHING AS PER BCBC 9.19.1.3.

-DWELLING GLAZING SECURITY REQUIREMENTS TO CONFORM TO BCBC 9.7.6 AND APPENDIX (A)9.7.5.3.(1).

-ALL EXTERIOR AND REQUIRED GUARDS TO BE 3'-6" (1070MM) HIGH WITH MAX. 3.9" (100MM) CLEAR OPENINGS. -ALL HANDRAILS SHALL BE A MINIMUM 2'-8" HIGH ABOVE THE NOSINGS.

-ALL STAIR TREADS TO BE 10 1/2 INCH MINIMUM AND AN 1/2 " NOSING. -ALARMS AND DETECTION SYSTEMS TO BE AS PER 3.2.4.1 OF THE BCBC.

ARCHITECTURAL DRAWINGS

A-001 PROJECT INFORMATION

A-002 ASSEMBLIES

A-100 FOUNDATION PLAN

A-101 LEVEL 1 PLAN

A-102 LEVEL 2 PLAN

A-103 ROOF DECK PLAN A-200 ELEVATIONS

A-201 ELEVATIONS

A-300 SECTIONS

A-500 DETAILS

A-501 DETAILS

13' - 1 1/2" [4000]

FLANKING STREET SETBACK

Plot Date Drawing No. 03.16.23 **PROJECT** 1010 MARTIN **DRAWING TITLE** PROJECT INFORMATION

Revision No., Date and Description 04.07.22 - FOR REVIEW

05.15.22 - FOR DP/BP 02.21.23 - FOR DP/BP

03.16.23 - FOR DP/DVP

PHONE:250-448-7801

205-1626 Richter Street Kelowna, BC V1Y 2M3

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shall check and verify all levels, dimensions data and conditions on the site prior to commencement of any work. Any discrepancies are to be reported immediately to LIME Architecture Inc. Do not Scale any dimensions from this drawing

All trades are to execute the work in accordance with the current municipality

building by-laws and requirements of other local authorities having jurisdiction as well as the british columbia building code -

(most recent edition) including all published revisions and addenda. All trades shall assume full responsiblity for the locations

and protection of all under and above ground utilities, wires and conduit connections, including (but not limited to)

water, sewer, gas, hydro and telephone.

FOR DP/DVP

TRUE NORTH PROJECT NORTH

Kelowna:

Heating Days >3000, <4000 = Zone 5 Minimum RSI Values Required (with HRV):

Ceilings below attics = 6.91
Cathedral ceilings/flat roofs = 4.67
Walls = 2.97
Floors over unheated spaces = 4.67

Basement Walls= 2.98
Unheated floor below frost line= uninsulated
Unheated floor above frost line= 1.96
Heated floors= 2.32

RSI Parallel = 100

Marea of framing + Marea of cavity RSIc

WALL TY	<u> </u>	T			RSI _F RSI _C	
TYPE NO.	COMPONENTS		COMPONENT RSI	COMPONENT EFFECTIVE RSI		TOTAL EFFECTIV RSI
E1	EXTERIOR WALL STUCCO	EXTERIOR AIR FILM STUCCO FINISH COAT (1/8", 3mm MIN.) STUCCO SCRATCH COAT ON METAL LATH (2 COATS, 1/4", 6mm MIN. EACH) 15 LBS BUILDING PAPER 1/2" SHEATHING (PLYWOOD OR OSB) 2x6" WOOD STUDS @ 24" O.C STANDARD FRAMING R-24 BATT INSULATION (CAN/ULC-S702) 6mil POLY V.B. 1/2" GYPSUM BOARD (PAINTED) INTERIOR AIR FILM	(.03) (.0027) (.0108) (.109) (1.19) - 20% INSULATED STUD ASSEMBLY (4.23) - 80% INSULATED STUD ASSEMBLY - (.08) (.12)	(.03) (.014) (.109) (3.62) (.08) (.12)	+/-71/8"	3.97
E2	EXTERIOR WALL HARDIE	EXTERIOR AIR FILM HARDIE FIBRE CEMENT SIDING (5/16", 8mm) 15 LBS BUILDING PAPER 1/2" SHEATHING (PLYWOOD OR OSB) 2x6" WOOD STUDS @ 24" O.C STANDARD FRAMING R-24 BATT INSULATION (CAN/ULC-S702) 6mil POLY V.B. 1/2" GYPSUM BOARD (PAINTED) INTERIOR AIR FILM	(.03) (.003/mm) (.109) (1.19) - 20% INSULATED STUD ASSEMBLY (4.23) - 80% INSULATED STUD ASSEMBLY (.08) (.12)	(.03) (.026) (.109) (3.62) (.08) (.12)	+/- 6 3/4"	3.99
E2B	EXTERIOR WALL FIBRE CEMENT (NON-INSULATED)	EXTERIOR AIR FILM FIBRE CEMENT SIDING (5/16", 8mm) 15 LBS BUILDING PAPER 1/2" SHEATHING (PLYWOOD OR OSB) 2x6" WOOD STUDS @ 24" O.C STANDARD FRAMING 6mil POLY V.B. 1/2" GYPSUM BOARD (PAINTED) INTERIOR AIR FILM			+/- 6 5/8" +/- 6 5/8"	
E3	EXTERIOR WALL BRICK VENEER	EXTERIOR AIR FILM FINISH AS INDICATED ON DWGS (1 1/2" CULTURED STONE) 15 LBS BUILDING PAPER (SHINGLED AS PER CODE) 1/2" SHEATHING (PLYWOOD OR OSB) 2x6" WOOD STUDS @ 24" O.C STANDARD FRAMING R-24 INSULATION 6mil POLY V.B. 1/2" GYPSUM BOARD (PAINTED) INTERIOR AIR FILM	(.03) (0.0003/mm) (.109) (1.19) - 20% INSULATED STUD ASSEMBLY (4.23) - 80% INSULATED STUD ASSEMBLY (.08) (.12)	(.03) (0.011) (.109) (3.62) - (.08) (.12)	+/- 81/2"	3.97
E4	EXTERIOR FOUNDATION (UNINSULATED)	8" (203mm) C.I.P. CONCRETE (SEE STRUCTURAL)				
E5	EXTERIOR FOUNDATION (UNINSULATED)	6" (152mm) C.I.P. CONCRETE (SEE STRUCTURAL)				
<u></u>	INTERIOR WALL	2X4 WOOD STUDS SPACED 24" O.C. 1/2" GYPSUM BOARD EACH SIDE			<u> </u>	
(12)	INTERIOR WALL (LOADBEARING AND PLUMBING)	2X6 WOOD STUDS SPACED 16" O.C. 1/2" GYPSUM BOARD EACH SIDE			6 1/2"	
(IPW)	1 HR BEARING 1 HR NON-BEARING STC: 54 (BCBC WALL TYPE: W13c A-9.10.3.1.A)	TWO ROWS 2X4 WOOD STUDS ON SEPARATE 2X4 PLATES (PLATES SET 1" APART), STUDS SPACED @ 16" O.C. (24" MAX - STUDS TO ALIGN ON ALL THREE LEVELS) 3-1/2" THICK ABSORPTIVE MATERIAL ONE SIDE 1 LAYER 5/8" TYPE 'X' GYPSUM BOARD EACH SIDE (NOTE: CUT GYPSUM BOARD TO FIT TO U/S ROOF SHEATHING AND FILL 1/4" NOMINAL GAP WITH ACOUSTICAL SEALANT)				

FLOOR TYPES

TYPE NO.	COMPONENTS		COMPONENT	COMPONENT EFFECTIVE RSI		TOTAL EFFECTIVE RSI
F1	INTERIOR ENG. WOOD FLOORING SYSTEM (NON-INSULATED)	FINISH FLOORING ENGINEERED WOOD FLOOR (SEE STRUCTURAL) 5/8" GYPSUM BOARD (PAINTED)			PRE ENG. +-/-1'-11/4"	
F2	INTERIOR ENG. WOOD FLOORING SYSTEM (EXTERIOR PROJECTION)	INTERIOR AIR FILM FINISH FLOORING 3/4" T&G PLYWOOD FLOORING 6 MIL. POLY ENGINEERED WOOD FLOOR (SEE STRUCTURAL) R-31 MIN. CLOSED CELL SPRAY FOAM INSULATION NON-VENTED SOFFIT EXTERIOR AIR FILM	(.16) (.16) (2.05) - 9% INSULATED FLOOR ASSEMBLY (5.46) - 91% INSULATED FLOOR ASSEMBLY (.03)	(.16) (.16) - (5.15) (.03)	PRE ENG.	5.5
F3	CONCRETE SLAB ON GRADE	INTERIOR AIR FILM 4" CONC. SLAB (SEE STRUCTURAL) (2400 kg/m3) STEEL REINFORCING (SEE STRUCTURAL) 6 MIL. POLY 2" EXTRUDED POLYSTYRENE (XPS) (AT SLAB ON GRADE TO EXTEND 48" MIN. INTO BUILDING FROM PERIMETER EDGE) FILL (AS PER CIVIL AND ARCHITECTURAL GENERAL NOTES) UNDISTURBED SOLID BEARING	(.16) (.04) (1.76)	(.16) (.04) (1.76)	#	1.96
F4	CONCRETE SLAB ON GRADE (NON-INSULATED)	4" CONC. SLAB (SEE STRUCTURAL) (2400 kg/m3) STEEL REINFORCING (SEE STRUCTURAL) 6 MIL. POLY FILL (AS PER CIVIL AND ARCHITECTURAL GENERAL NOTES) UNDISTURBED SOLID BEARING			g	

ROOF TYPES

TYPE NO.	COMPONENTS		COMPONENT RSI	COMPONENT EFFECTIVE RSI	TOTAL EFFECTIVE RSI
RI	TYPICAL FLAT ROOF ASSEMBLY	EXTERIOR AIR FILM 2 PLY. MOD. BIT ROOFING SYSTEM PER RCABC 7/16" OSB SHEATHING VENTED AIR SPACE 24" ENG. ROOF TRUSSES (CEILING WITH TYPICAL TRUSS) (CONFIRM WITH STRUCTURAL) 14" BLOWN CELLULOSIC INSULATION (TO CAN/ULC-S703) 6mil POLY V.B. 1/2" GYPSUM BOARD (PAINTED) INTERIOR AIR FILM	(.03) (NEG) (NEG) (.76) - 14% INSULATED TRUSS ASSEMBLY (8.89) - 86% INSULATED TRUSS ASSEMBLY (.08) (.11)	(.03) (7.75) (.08) (.11)	2% MIN. SLOPE
⟨R2⟩	TYPICAL ROOF DECK ASSEMBLY	EXTERIOR AIR FILM PAVER PAV-EL PEDESTAL (SHIM TO ACHIEVE LEVEL FINISHED FACE) 2 PLY. MOD. BIT ROOFING SYSTEM PER RCABC 7/16" ASPHALT IMPREGNATED FIBREBOARD (PER RCABC) SHEATHING AIR SPACE 24" ENG. ROOF TRUSSES (CEILING WITH TYPICAL TRUSS) (CONFIRM WITH STRUCTURAL) 14" BLOWN CELLULOSIC INSULATION (TO CAN/ULC-S703) 6mil POLY V.B. 1/2" GYPSUM BOARD (PAINTED) INTERIOR AIR FILM	(.03) (NEG) (.76) - 14% INSULATED TRUSS ASSEMBLY (8.89) - 86% INSULATED TRUSS ASSEMBLY - (.08) (.11)	(.03) (.03) (.7.75) (.08) (.11)	7.97
R3	TYPICAL SLOPED ROOF ASSEMBLY (UNINSULATED)	EXTERIOR AIR FILM ASPHALT SHINGLES 15 LBS BUILDING PAPER (SHINGLED AS PER CODE) 7/16" OSB SHEATHING VENTED AIR SPACE 24" ENG. ROOF TRUSSES (CEILING WITH TYPICAL TRUSS) (CONFIRM WITH STRUCTURAL) 20" BLOWN CELLULOSIC INSULATION (TO CAN/ULC-S703) 6mil POLY V.B. 1/2" GYPSUM BOARD (PAINTED) INTERIOR AIR FILM			PRE ENG. +/- 2' - 1 1/4" CONFIRM ON SITE

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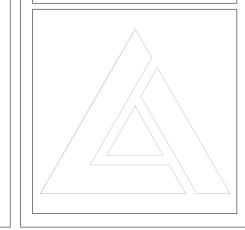
Revision No., Date and Description 04.07.22 - FOR REVIEW 05.15.22 - FOR DP/BP 02.21.23 - FOR DP/BP


03.16.23 - FOR DP/DVP

lot Date Drawing No.
16.23 A-002

PROJECT
1010 MARTIN

DRAWING TITLE
ASSEMBLIES



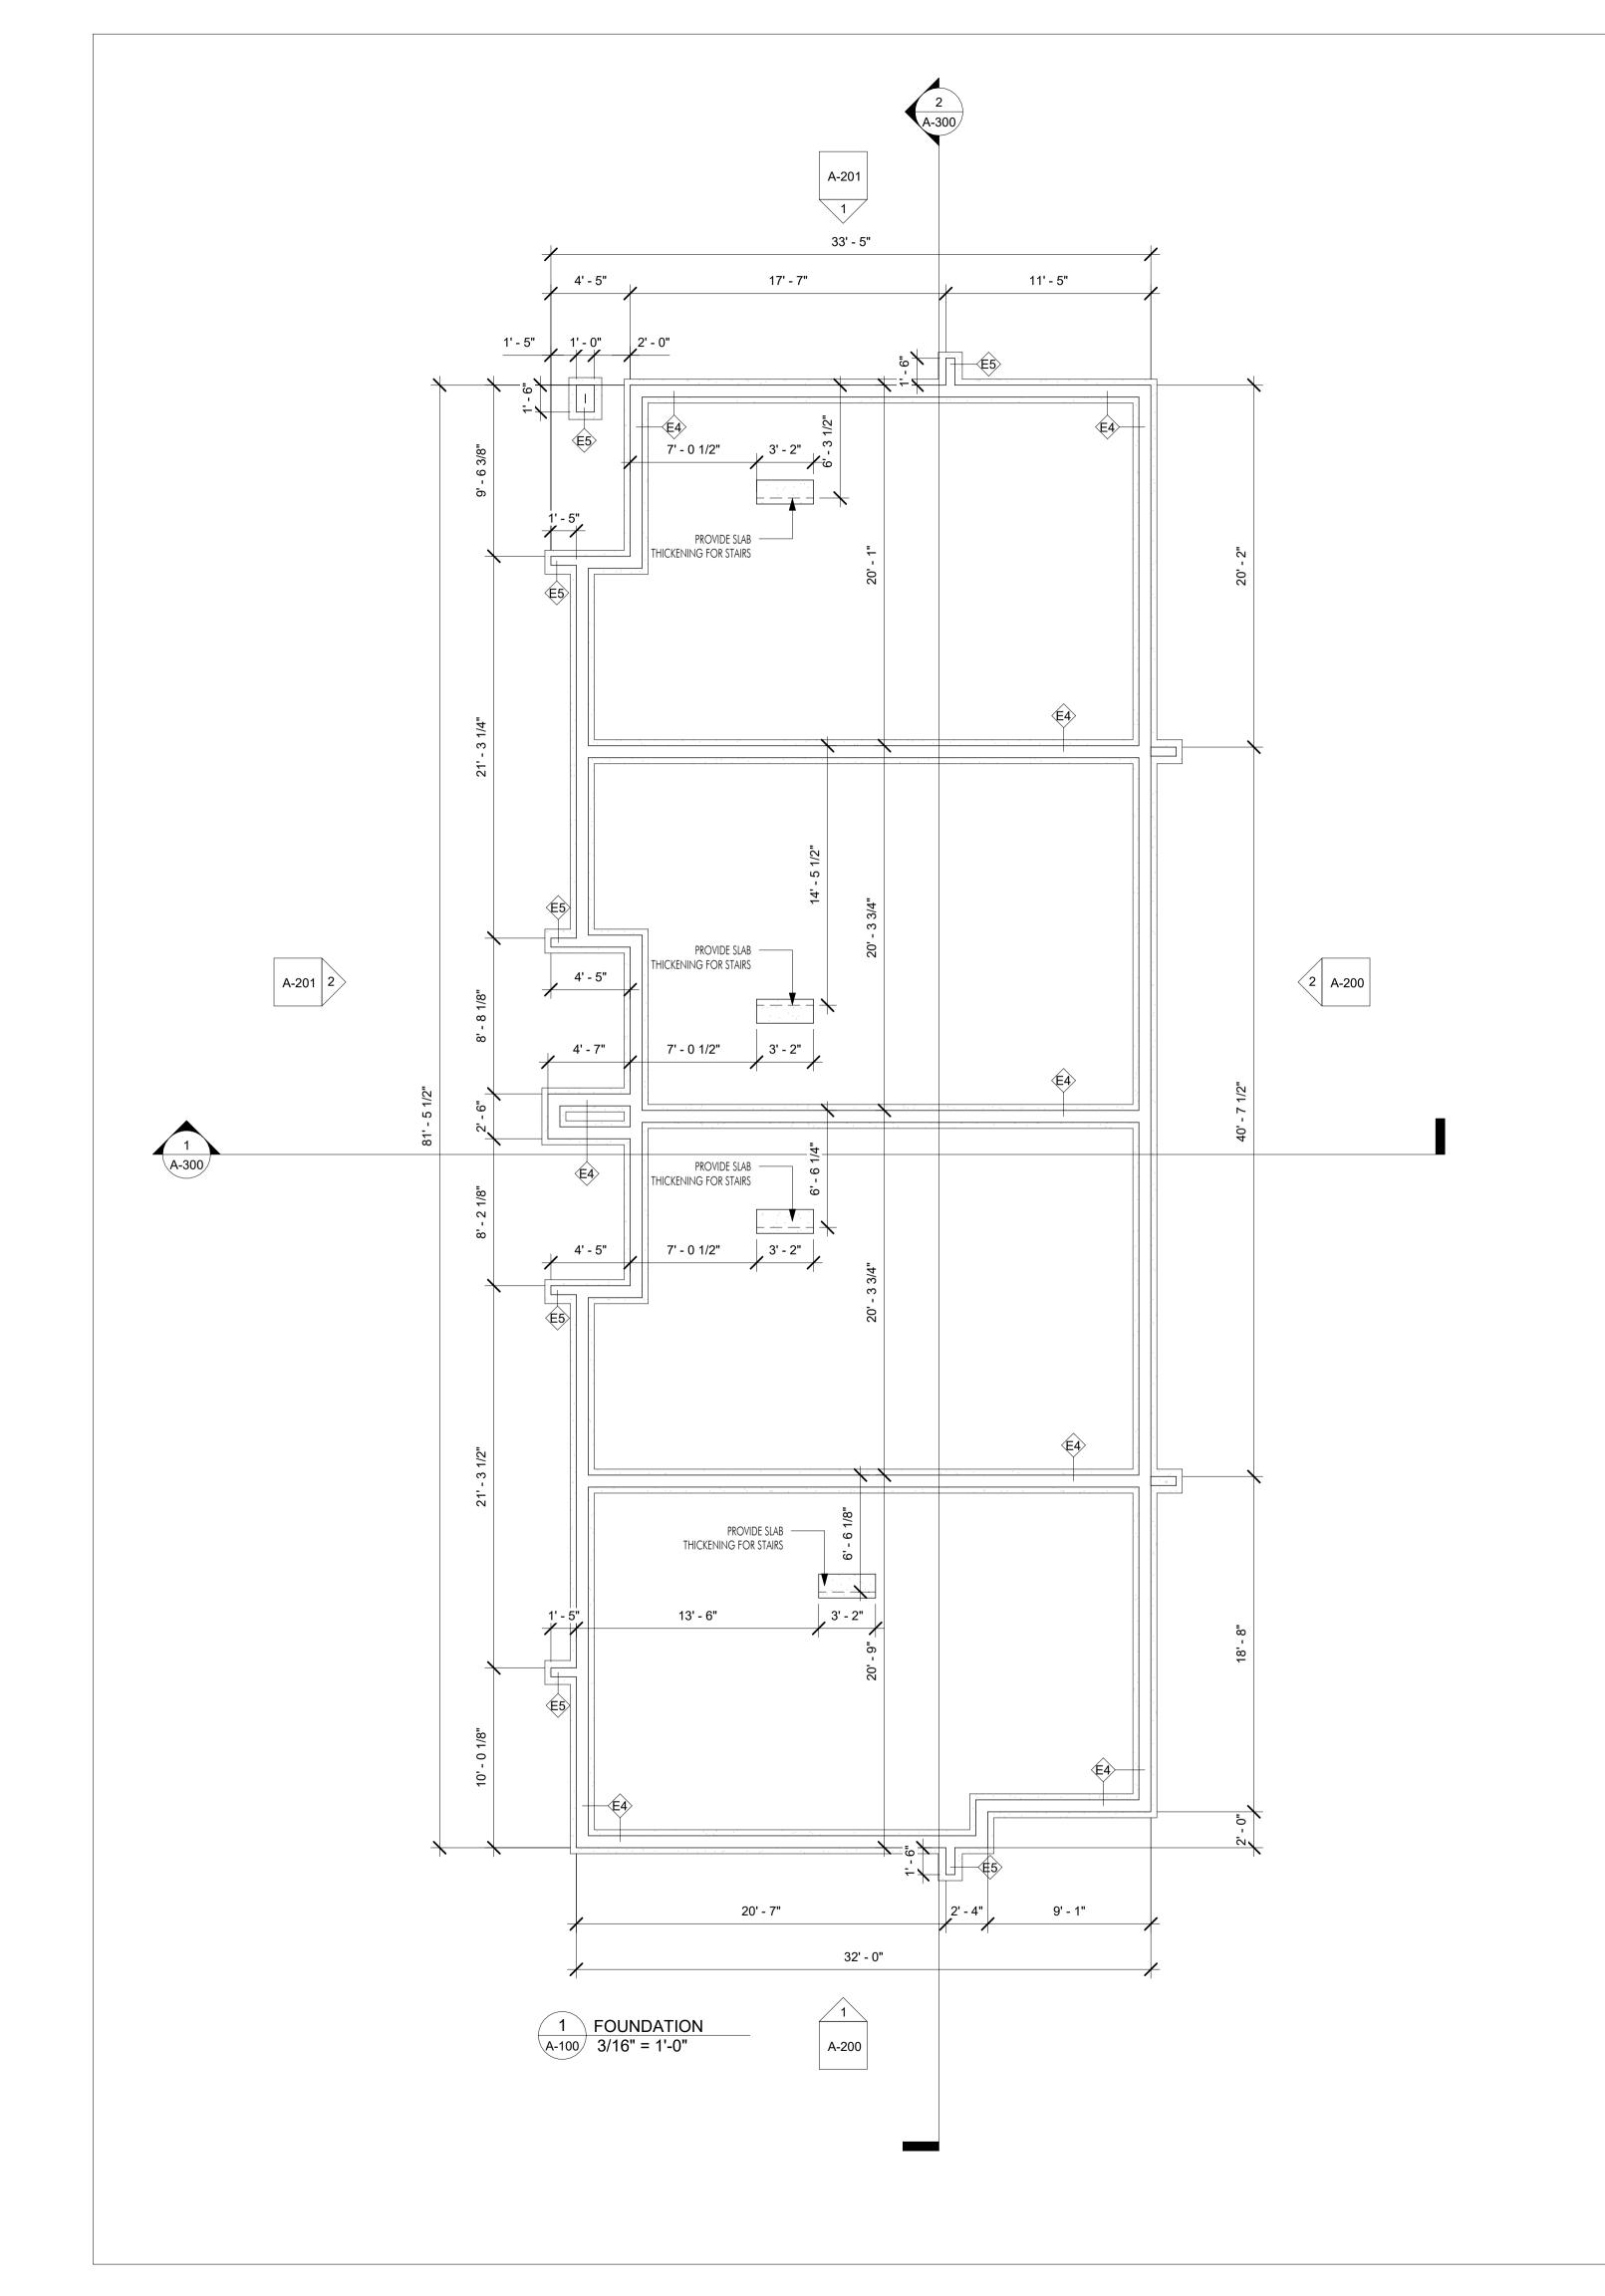



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Revision No., Date and Description


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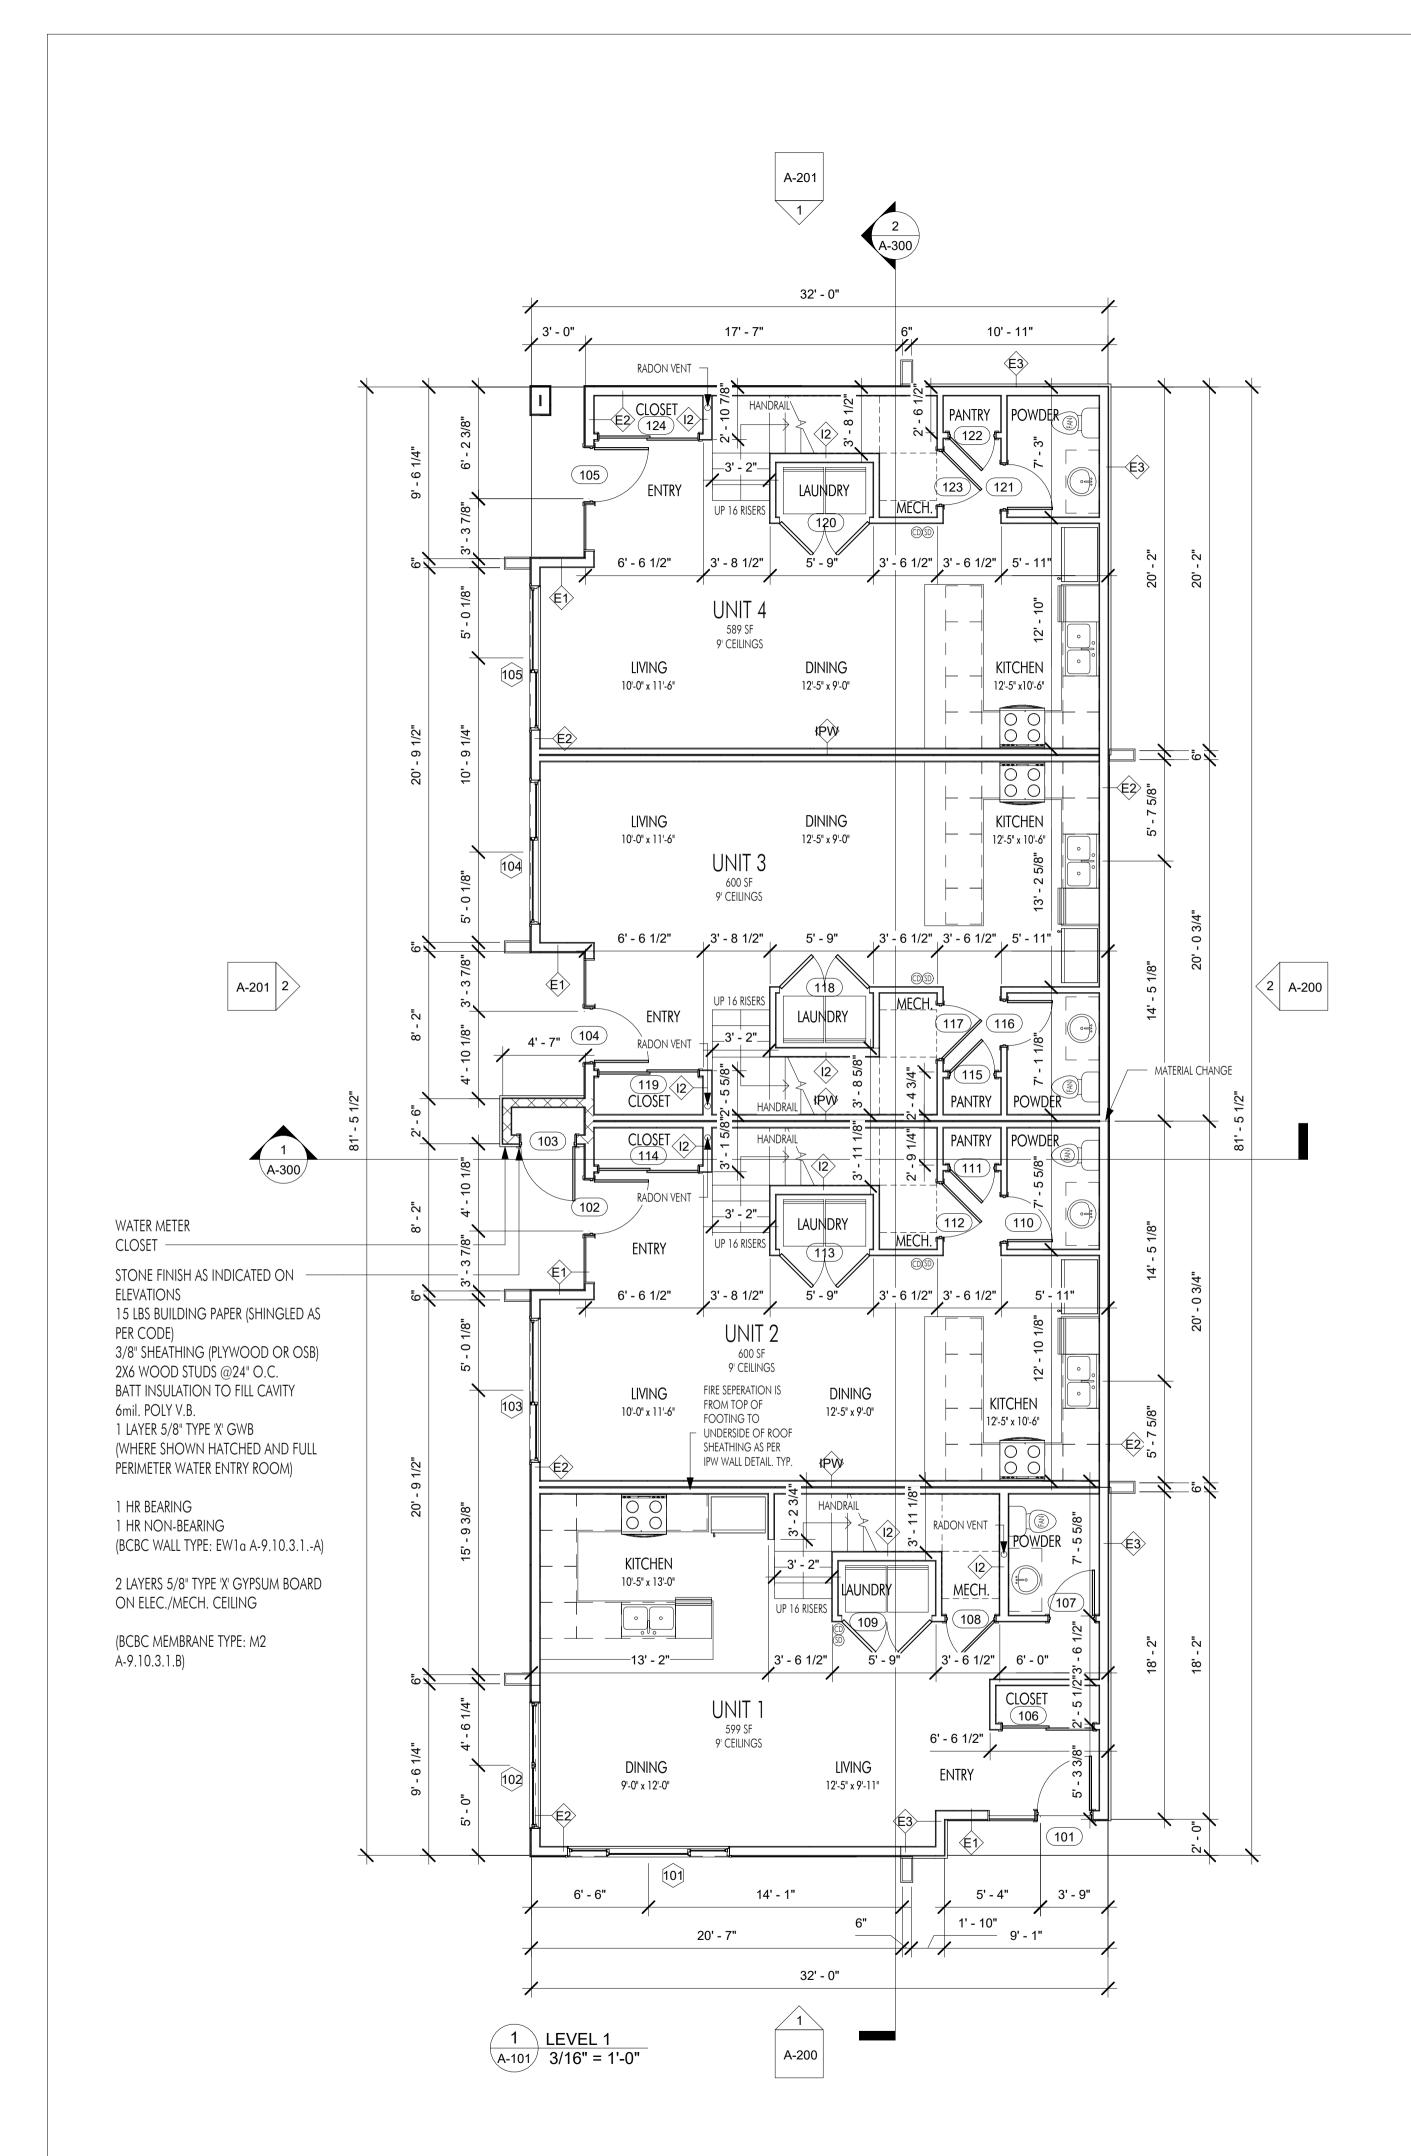
03.16.23

PROJECT

1010 MARTIN

DRAWING TITLE



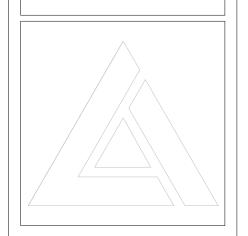

	Entry Level Door Schedule					
Mark	Width	Height	Description	Comments	Fire Rating	
101	3' - 0"	8' - 0"		5'-6" x 8'-0" Overall width sidelight		
102	3' - 0"	8' - 0"		5'-6" x 8'-0" Overall width sidelight		
103	3' - 0"	8' - 0"		Single	20 MIN. FRR ON CLOSEI	
104	3' - 0"	8' - 0"		5'-6" x 8'-0" Overall width sidelight		
105	3' - 0"	8' - 0"		5'-6" x 8'-0" Overall width sidelight		
106	5' - 0"	6' - 8"		Sliding Double		
107	2' - 6"	6' - 8"		Single		
108	2' - 8"	6' - 8"		Single		
109	5' - 0"	6' - 8"		Double		
110	2' - 6"	6' - 8"		Single		
111	2' - 6"	6' - 8"		Single		
112	3' - 0"	6' - 8"		Single		
113	5' - 0"	6' - 8"		Double		
114	5' - 6"	6' - 8"		Sliding Double		
115	2' - 6"	6' - 8"		Single		
116	2' - 6"	6' - 8"		Single		
117	3' - 0"	6' - 8"		Single		
118	5' - 0"	6' - 8"		Double		
119	5' - 6"	6' - 8"		Sliding Double		
120	5' - 0"	6' - 8"		Double		
121	2' - 6"	6' - 8"		Single		
122	2' - 6"	6' - 8"		Single		
123	3' - 0"	6' - 8"		Single		
124	5' - 6"	6' - 8"		Sliding Double		

	Entry Level Window Schedule					
Mark	Width	Height	Head Height	Sill Height	Comments	
101	9' - 0"	6' - 0"	8' - 0"	2' - 0"		
102	7' - 0"	6' - 0"	8' - 0"	2' - 0"		
103	8' - 0"	6' - 0"	8' - 0"	2' - 0"		
104	8' - 0"	6' - 0"	8' - 0"	2' - 0"		
104	2' - 6"	8' - 0"	8' - 0"	0' - 0"		
105	8' - 0"	6' - 0"	8' - 0"	2' - 0"		

NOTE: WINDOWS TO BE HIGH PERFORMING DOUBLE GLAZED TO ACHIEVE STEP 3.

INTERIOR DOORS:

DOOR ROUGH OPENINGS VERSUS ACTUAL DOOR DIMENSIONS AS FOLLOWS (CONFIRM WITH MANUFACTURER):

DOOR TYPE	ADDITIONAL HEIGHT	ADDITIONAL WIDTH
STANDARD SINGLE SWING:	+2-1/2"	+2"
BI-FOLD: BI-PASS (WITH GLASS DOORS): BI-PASS (WITHOUT GLASS):	+1-1/2" +1-1/2" +1-1/2"	+1-1/4" +1-1/4" +0 (DOOR WIDTH)

WINDOWS/EXTERIOR DOORS:

WINDOW ROUGH OPENINGS VERSUS ACTUAL WINDOW/DOOR DIMENSIONS AS FOLLOWS (CONFIRM WITH MANUFACTURER):

TYPE	ADDITIONAL HEIGHT	ADDITIONAL WIDTH
STANDARD EXTERIOR WINDOW:	+1/2"	+1/2"
SLIDING EXTERIOR DOORS:	+1/2"	+1/2"
STANDARD EXTERIOR DOOR:	+1"	+1"

NOTE: ALL INTERIOR WALLS TO BE 11, U.N.O.



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Revision No., Date and Description

03.28.22 - FOR REVIEW 04.07.22 - FOR REVIEW 05.15.22 - FOR DP/BP 02.21.23 - FOR DP/BP 03.16.23 - FOR DP/DVP


Plot Date 03.16.23

PROJECT

1010 MARTIN

DRAWING TITLE ENTRY LEVEL PLAN



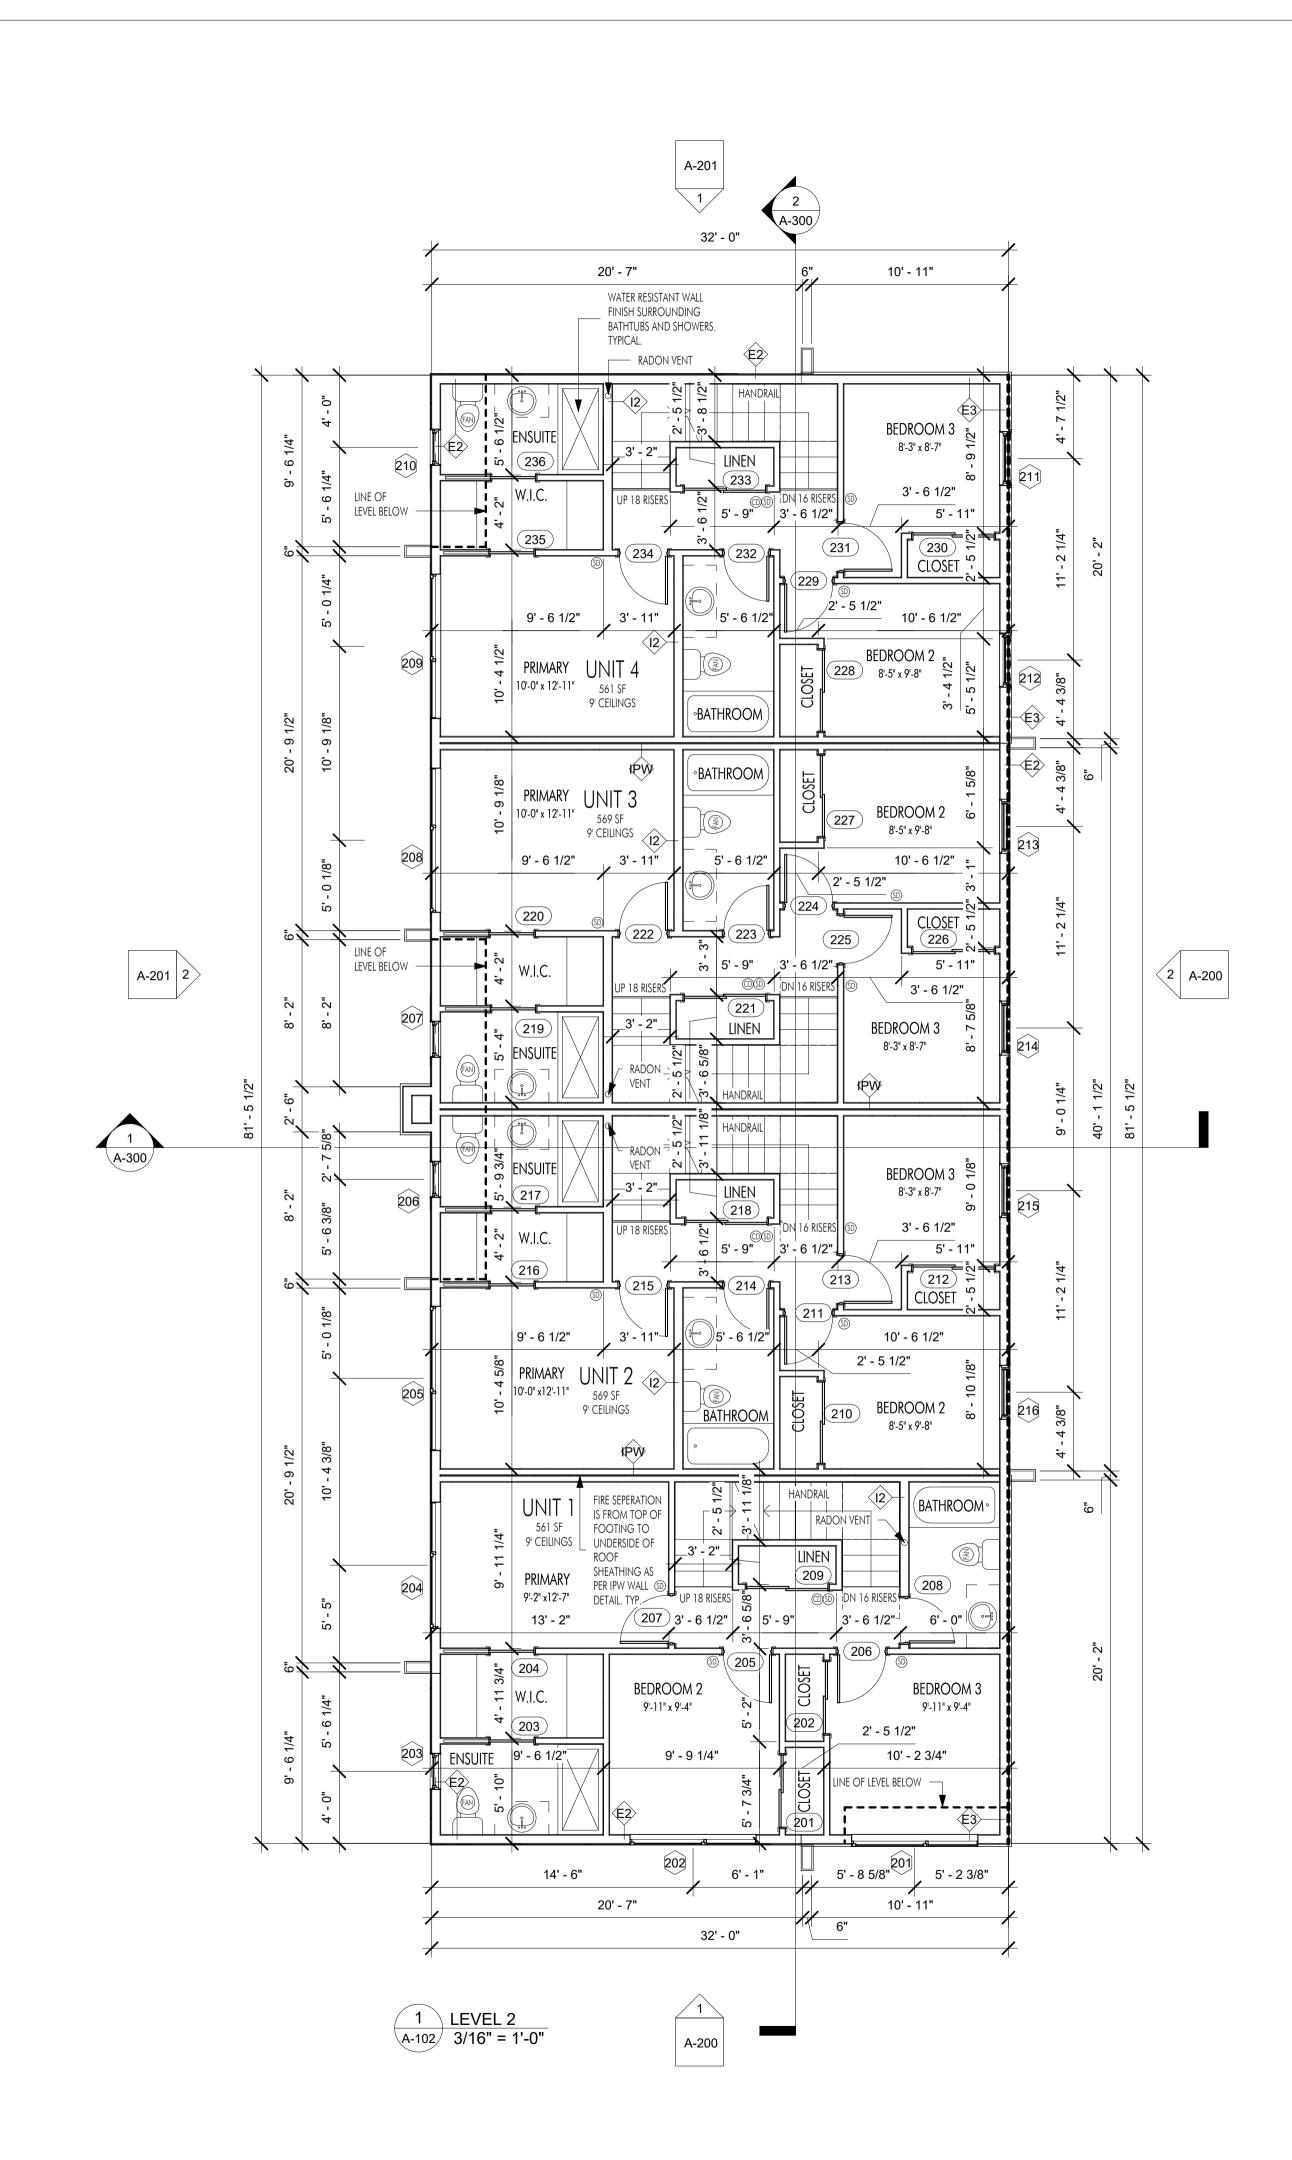

		Upper	Level Door S	chedule	
Mark	Width	Height	Description	Comments	Fire Rating
201	4' - 0"	6' - 8"		Sliding Double	
202	4' - 0"	6' - 8"		Sliding Double	
203	2' - 6"	6' - 8"		Pocket	
204	2' - 6"	6' - 8"		Pocket	
205	2' - 8"	6' - 8"		Single	
206	2' - 8"	6' - 8"		Single	
207	2' - 8"	6' - 8"		Single	
208	2' - 6"	6' - 8"		Single	
209	4' - 6"	6' - 8"		Sliding Double	
210	4' - 6"	6' - 8"		Sliding Double	
211	2' - 8"	6' - 8"		Single	
212	4' - 6"	6' - 8"		Sliding Double	
213	2' - 8"	6' - 8"		Single	
214	2' - 6"	6' - 8"		Single	
215	2' - 8"	6' - 8"		Single	
216	2' - 6"	6' - 8"		Pocket	
217	2' - 6"	6' - 8"		Pocket	
218	4' - 6"	6' - 8"		Sliding Double	
219	2' - 6"	6' - 8"		Pocket	
220	2' - 6"	6' - 8"		Pocket	
221	4' - 6"	6' - 8"		Sliding Double	
222	2' - 8"	6' - 8"		Single	
223	2' - 6"	6' - 8"		Single	
224	2' - 8"	6' - 8"		Single	
225	2' - 8"	6' - 8"		Single	
226	4' - 6"	6' - 8"		Sliding Double	
227	4' - 6"	6' - 8"		Sliding Double	
228	4' - 6"	6' - 8"		Sliding Double	
229	2' - 8"	6' - 8"		Single	
230	4' - 6"	6' - 8"		Sliding Double	
231	2' - 8"	6' - 8"		Single	
232	2' - 6"	6' - 8"		Single	
233	4' - 6"	6' - 8"		Sliding Double	
234	2' - 8"	6' - 8"		Single	
235	2' - 6"	6' - 8"		Pocket	
236	2' - 6"	6' - 8"		Pocket	
	1	1		1	

	Up	per Level Wi	ndow Sched	lule	
Mark	Width	Height	Head Height	Sill Height	Comments
201	7' - 0"	6' - 0"	8' - 0"	2' - 0"	
202	7' - 0"	6' - 0"	8' - 0"	2' - 0"	
203	2' - 0"	6' - 0"	8' - 0"	2' - 0"	
204	7' - 0"	6' - 0"	8' - 0"	2' - 0"	
205	8' - 0"	6' - 0"	8' - 0"	2' - 0"	
206	2' - 0"	6' - 0"	8' - 0"	2' - 0"	
207	2' - 0"	6' - 0"	8' - 0"	2' - 0"	
208	8' - 0"	6' - 0"	8' - 0"	2' - 0"	
209	8' - 0"	6' - 0"	8' - 0"	2' - 0"	
210	2' - 0"	6' - 0"	8' - 0"	2' - 0"	
211	3' - 0"	6' - 0"	8' - 0"	2' - 0"	
212	3' - 0"	6' - 0"	8' - 0"	2' - 0"	
213	3' - 0"	6' - 0"	8' - 0"	2' - 0"	
214	3' - 0"	6' - 0"	8' - 0"	2' - 0"	
215	3' - 0"	6' - 0"	8' - 0"	2' - 0"	
216	3' - 0"	6' - 0"	8' - 0"	2' - 0"	
283	2' - 6"	8' - 0"	8' - 0"	0' - 0"	
287	2' - 6"	8' - 0"	8' - 0"	0' - 0"	

NOTE: WINDOWS TO BE HIGH PERFORMING DOUBLE GLAZED TO ACHIEVE STEP 3.

INTERIOR DOORS:

DOOR ROUGH OPENINGS VERSUS ACTUAL DOOR DIMENSIONS AS FOLLOWS (CONFIRM WITH MANUFACTURER):

DOOR TYPE	ADDITIONAL HEIGHT	<u>ADDITIONAL WIDTH</u>
STANDARD SINGLE SWING:	+2-1/2"	+2"
BI-FOLD: BI-PASS (WITH GLASS DOORS): BI-PASS (WITHOUT GLASS):	+ 1 - 1/2" + 1 - 1/2" + 1 - 1/2"	+1-1/4" +1-1/4" +0 (DOOR WIDTH)

WINDOWS/EXTERIOR DOORS:

WINDOW ROUGH OPENINGS VERSUS ACTUAL WINDOW/DOOR DIMENSIONS AS FOLLOWS (CONFIRM WITH MANUFACTURER):

<u>TYPE</u>	<u>ADDITIONAL HEIGHT</u>	ADDITIONAL WIDTH
STANDARD EXTERIOR WINDOW:	+1/2"	+1/2"
SLIDING EXTERIOR DOORS:	+1/2"	+1/2"
STANDARD EXTERIOR DOOR:	+1"	+1"

NOTE: ALL INTERIOR WALLS TO BE 11, U.N.O.



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Revision No., Date and Description


03.28.22 - FOR REVIEW 04.07.22 - FOR REVIEW 05.15.22 - FOR DP/BP 02.21.23 - FOR DP/BP 03.16.23 - FOR DP/DVP


Plot Date 03.16.23

PROJECT

1010 MARTIN

DRAWING TITLE UPPER LEVEL PLAN

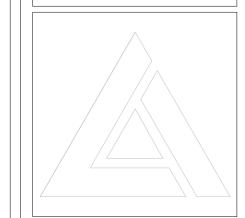

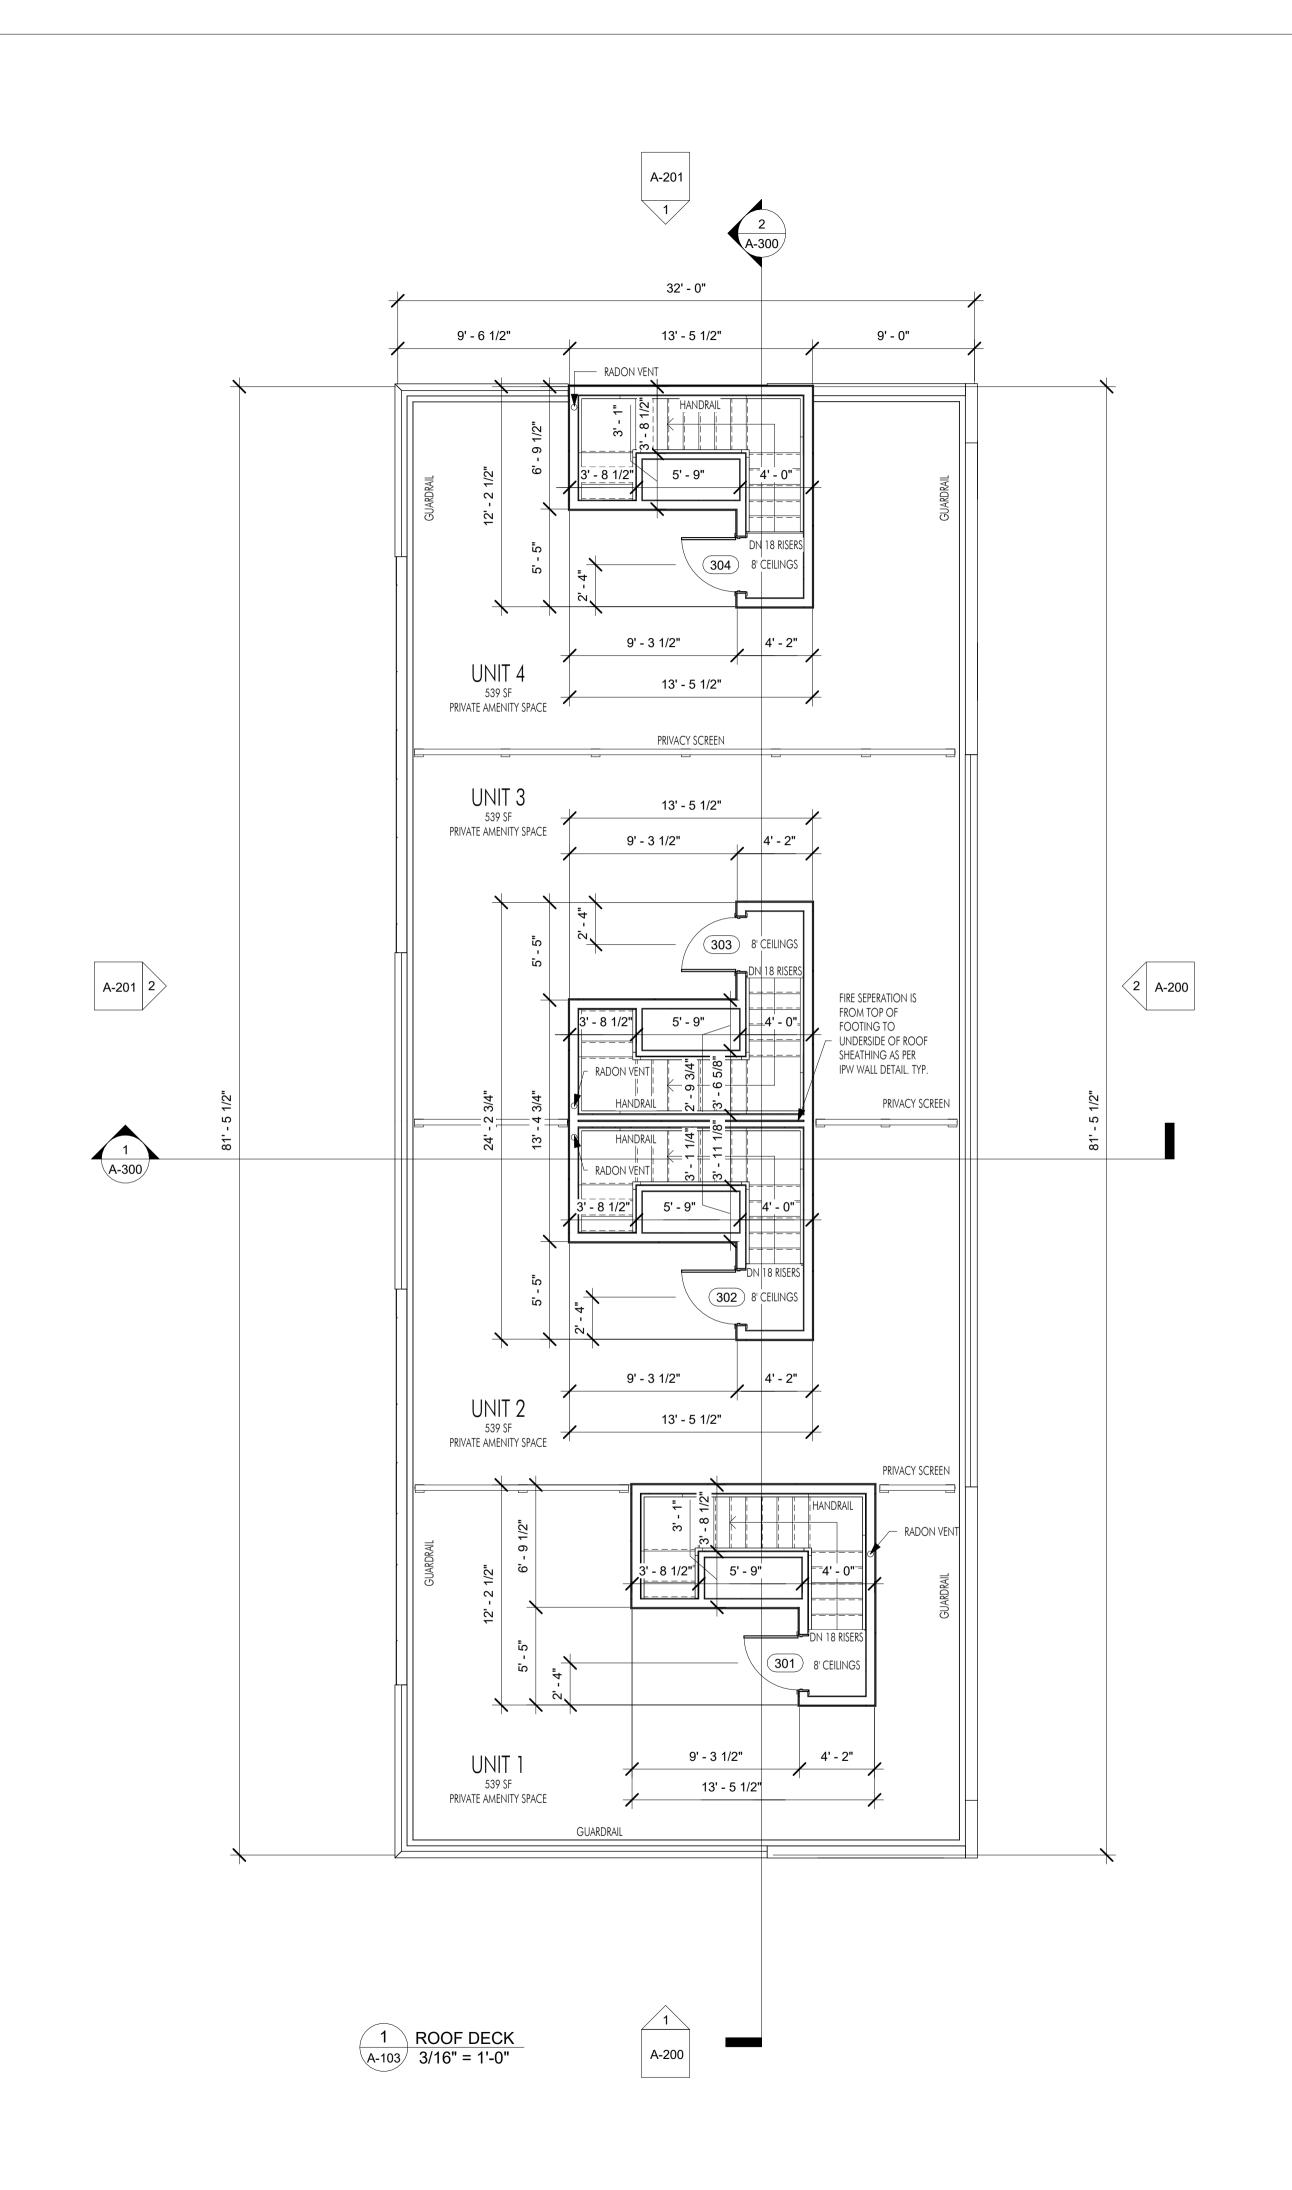

	Roof Deck Door Schedule					
Mark	Width	Height	Description	Type Comments	Fire Rating	
301	3' - 0"	6' - 8"		Single		
302	3' - 0"	6' - 8"		Single		
303	3' - 0"	6' - 8"		Single		
304	3' - 0"	6' - 8"		Single		

NOTE: WINDOWS TO BE HIGH PERFORMING DOUBLE GLAZED TO ACHIEVE STEP 3.

INTERIOR DOORS:

DOOR ROUGH OPENINGS VERSUS ACTUAL DOOR DIMENSIONS AS FOLLOWS (CONFIRM WITH MANUFACTURER):

DOOR TYPEADDITIONAL HEIGHTADDITIONAL WIDTHSTANDARD SINGLE SWING:+2-1/2"+2"BI-FOLD:+1-1/2"+1-1/4"BI-PASS (WITH GLASS DOORS):+1-1/2"+1-1/4"BI-PASS (WITHOUT GLASS):+1-1/2"+0 (DOOR WIDTH)

WINDOWS/EXTERIOR DOORS:

WINDOW ROUGH OPENINGS VERSUS ACTUAL WINDOW/DOOR DIMENSIONS AS FOLLOWS (CONFIRM WITH MANUFACTURER):

+1"

TYPE
ADDITIONAL HEIGHT
ADDITIONAL WIDTH

STANDARD EXTERIOR WINDOW: +1/2" +1/2"

SLIDING EXTERIOR DOORS: +1/2" +1/2"

NOTE: ALL INTERIOR WALLS TO BE 11, U.N.O.

STANDARD EXTERIOR DOOR: +1"



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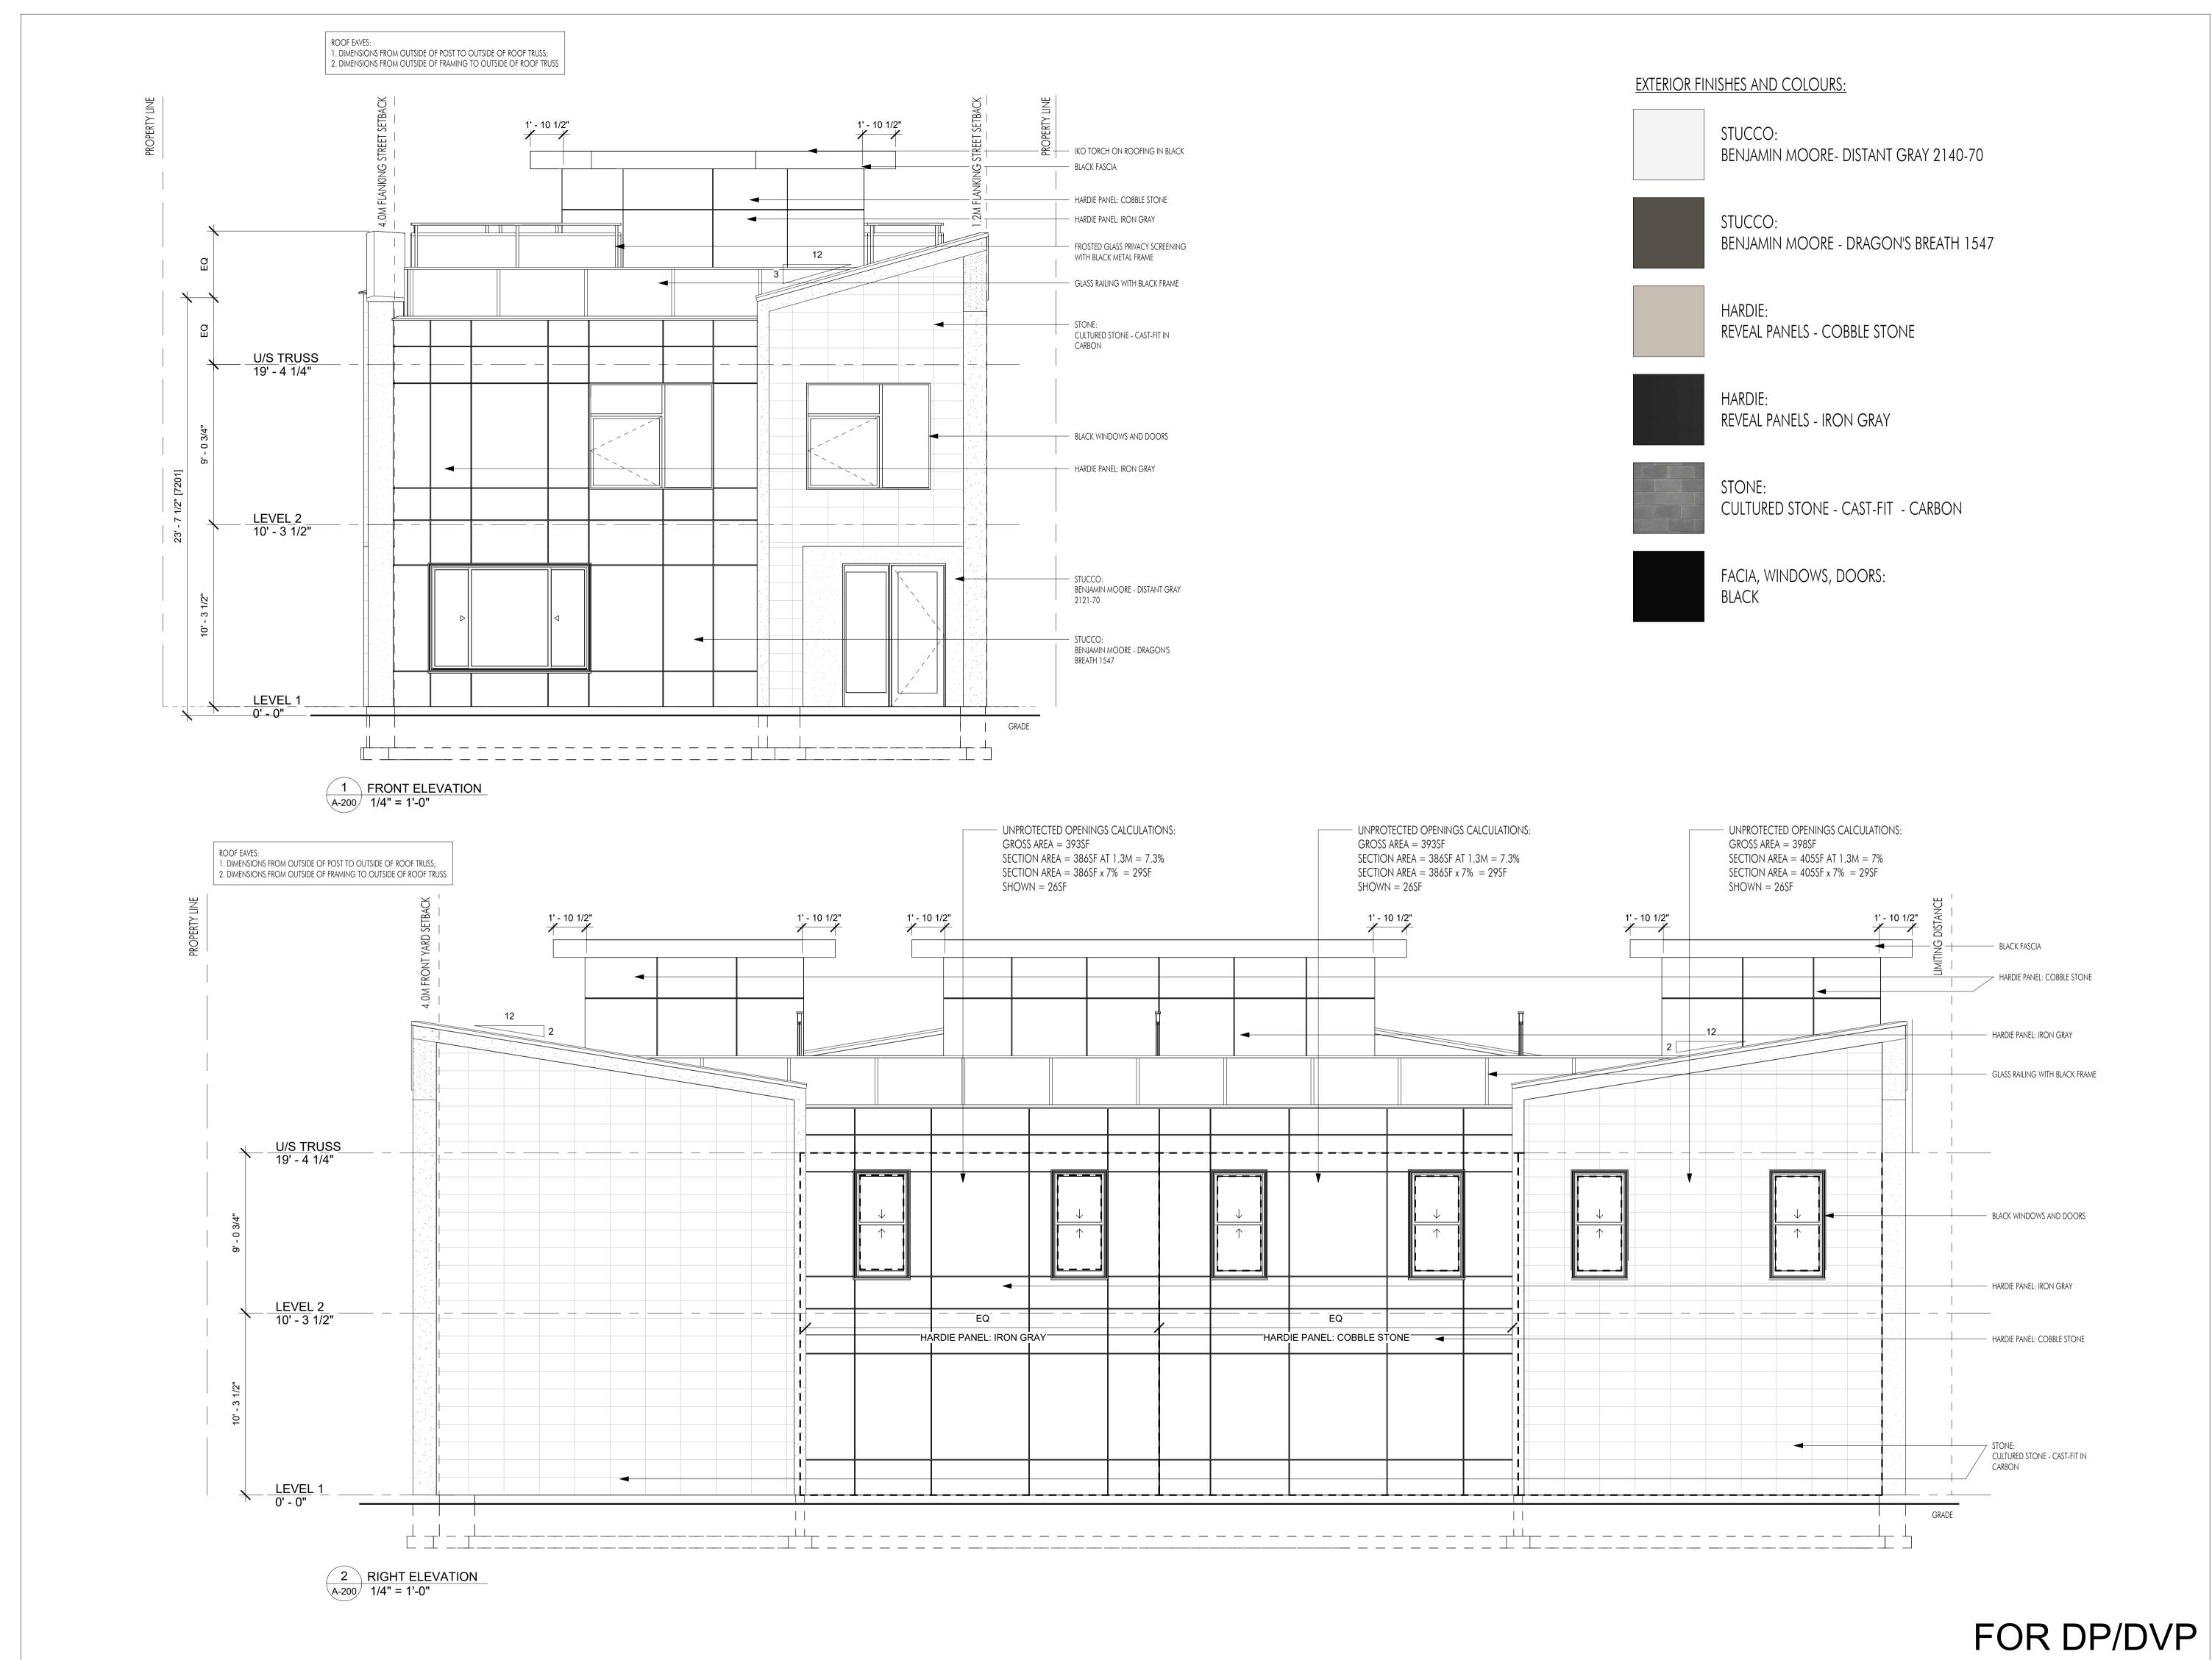
Revision No., Date and Description
04.07.22 - FOR REVIEW

04.07.22 - FOR REVIEW 05.15.22 - FOR DP/BP 02.21.23 - FOR DP/BP 03.16.23 - FOR DP/DVP

Plot Date Drawing No. 03.16.23 A-103

PROJECT
1010 MARTIN

DRAWING TITLE
ROOF DECK PLAN



LIM ARCHITECTURE I

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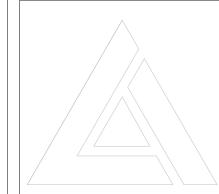
05.15.22 - FOR DP/BP 02.21.23 - FOR DP/BP 03.16.23 - FOR DP/DVP


Plot Date Drawing N

03.16.23 A-20

PROJECT 1010 MARTIN

DRAWING TITLE
ELEVATIONS



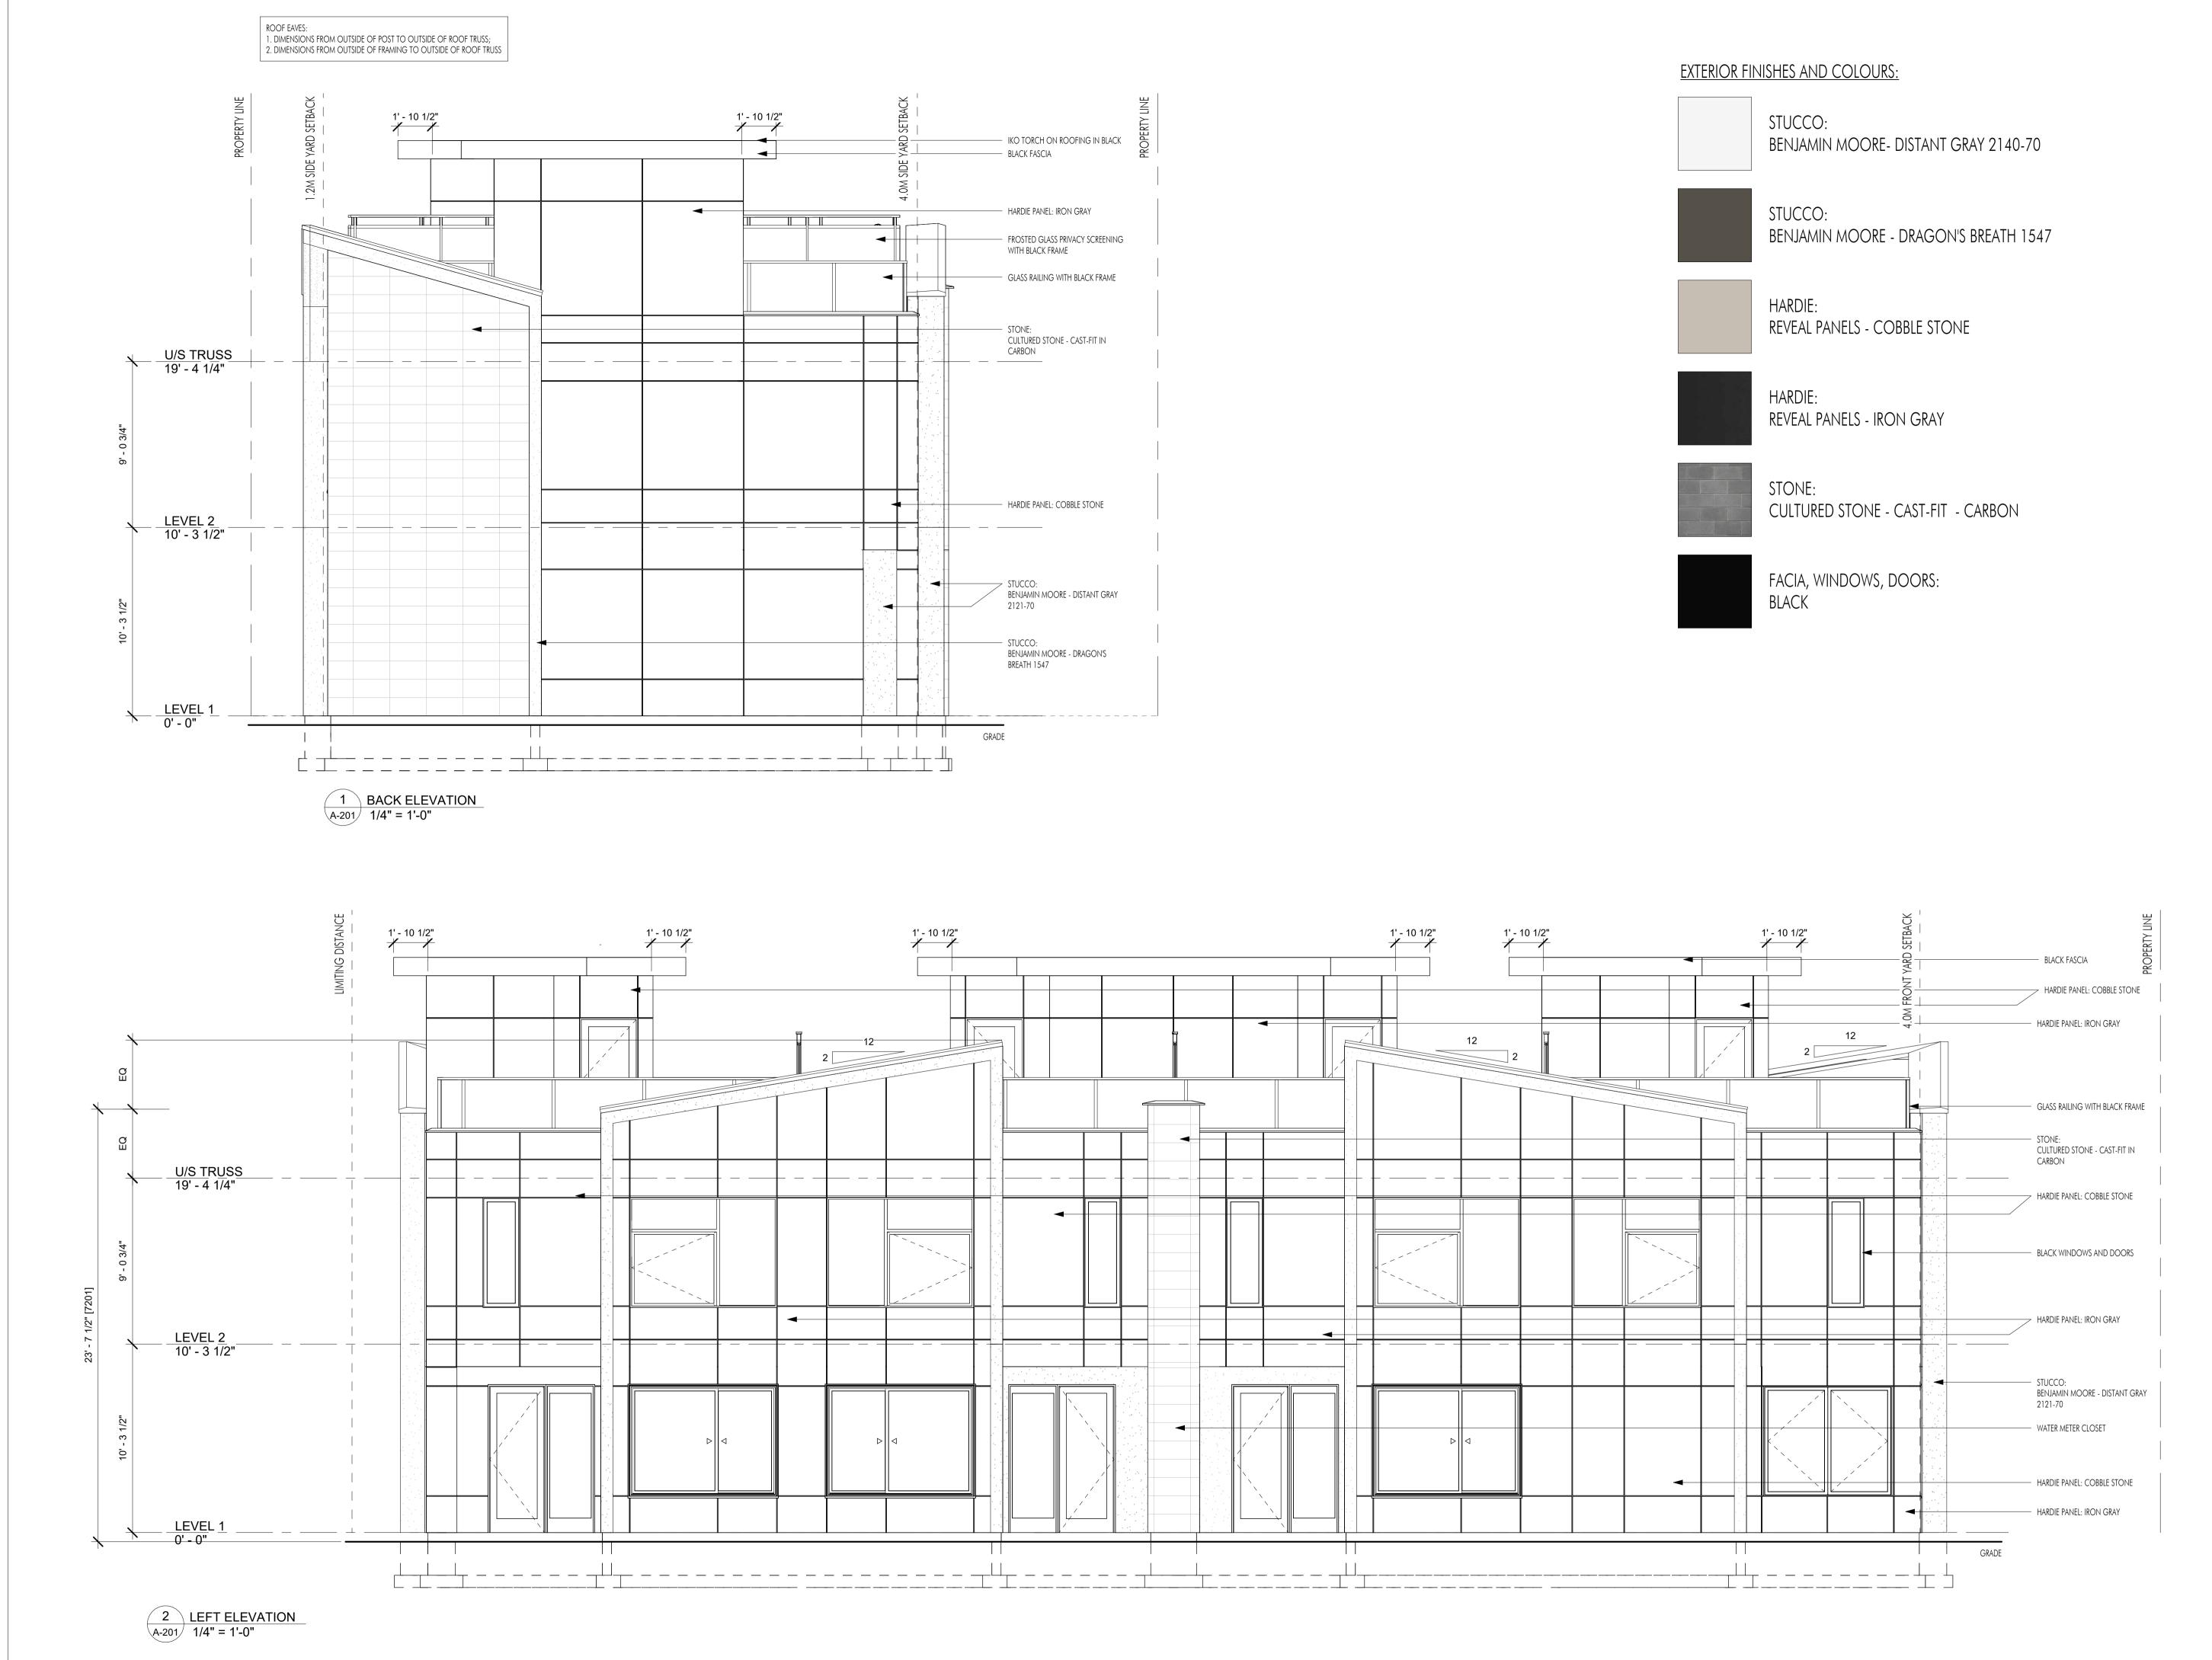

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03.16.23 - FOR DP/DVP


Plot Date Drawing No

03.16.23

PROJECT

PROJECT 1010 MARTIN

DRAWING TITLE
ELEVATIONS

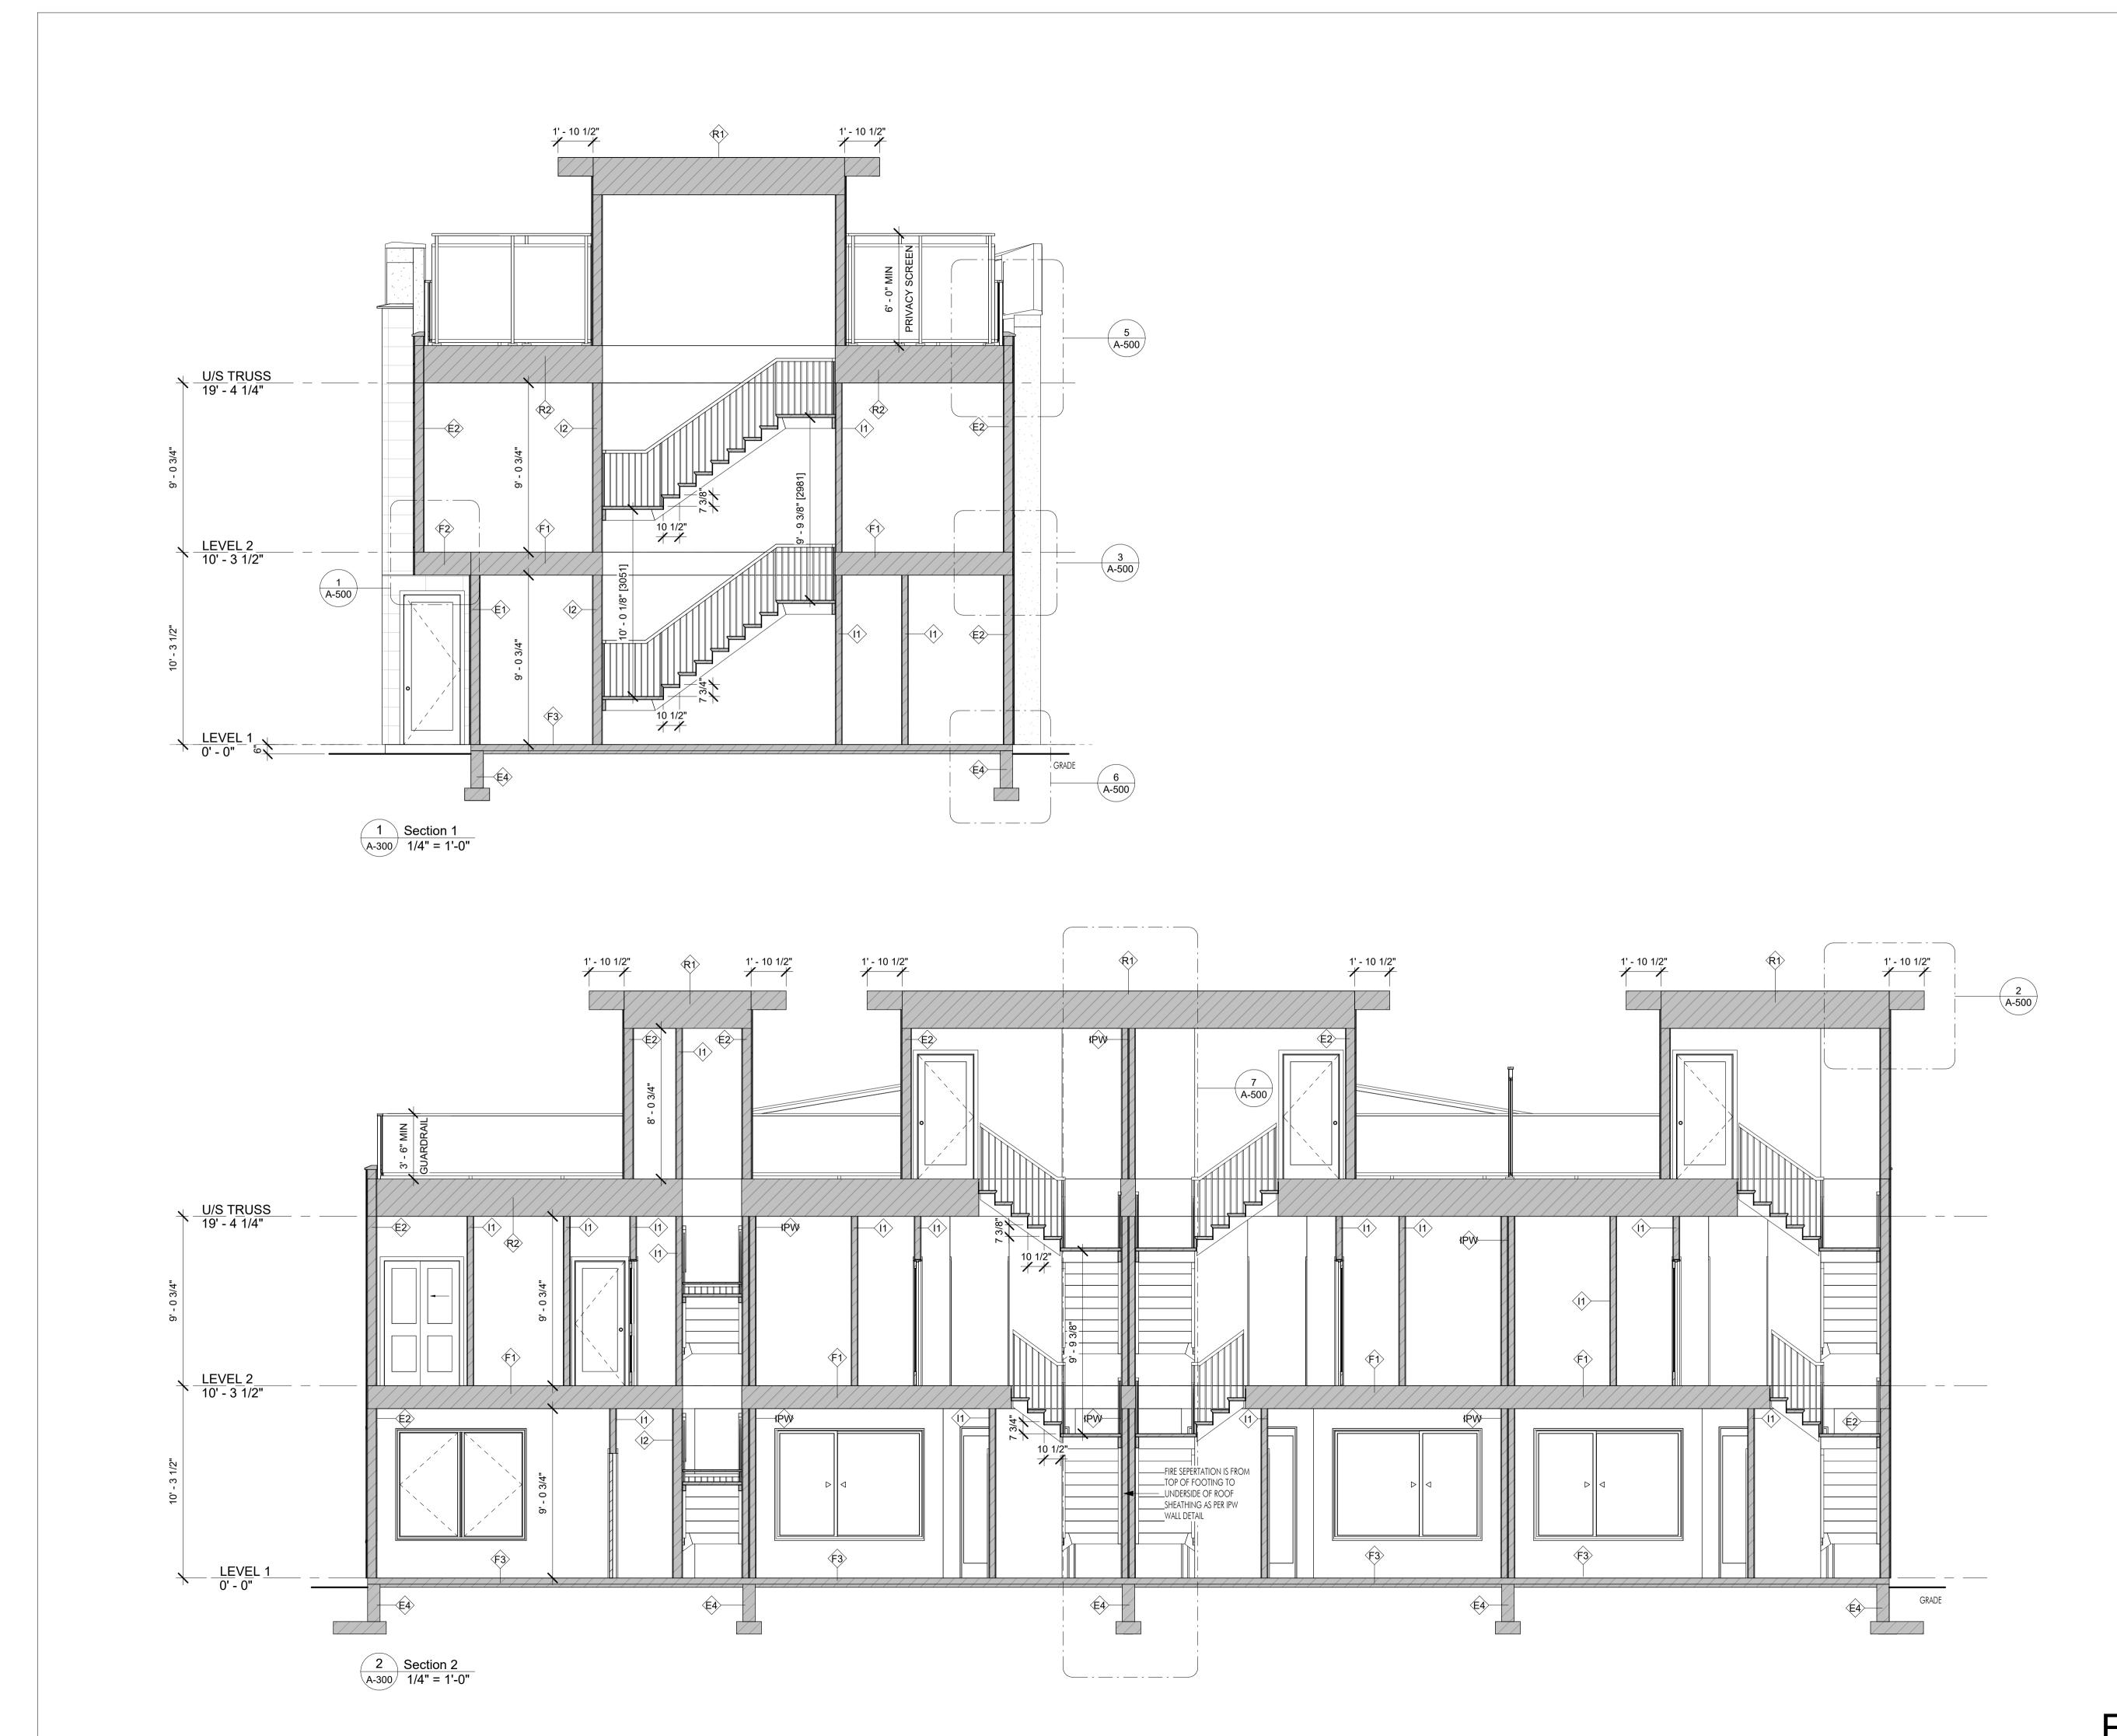

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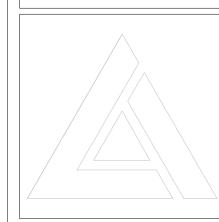
 03.16.23
 A-300


PROJECT

1010 MARTIN

DRAWING TITLE

DRAWING TITLE
SECTIONS



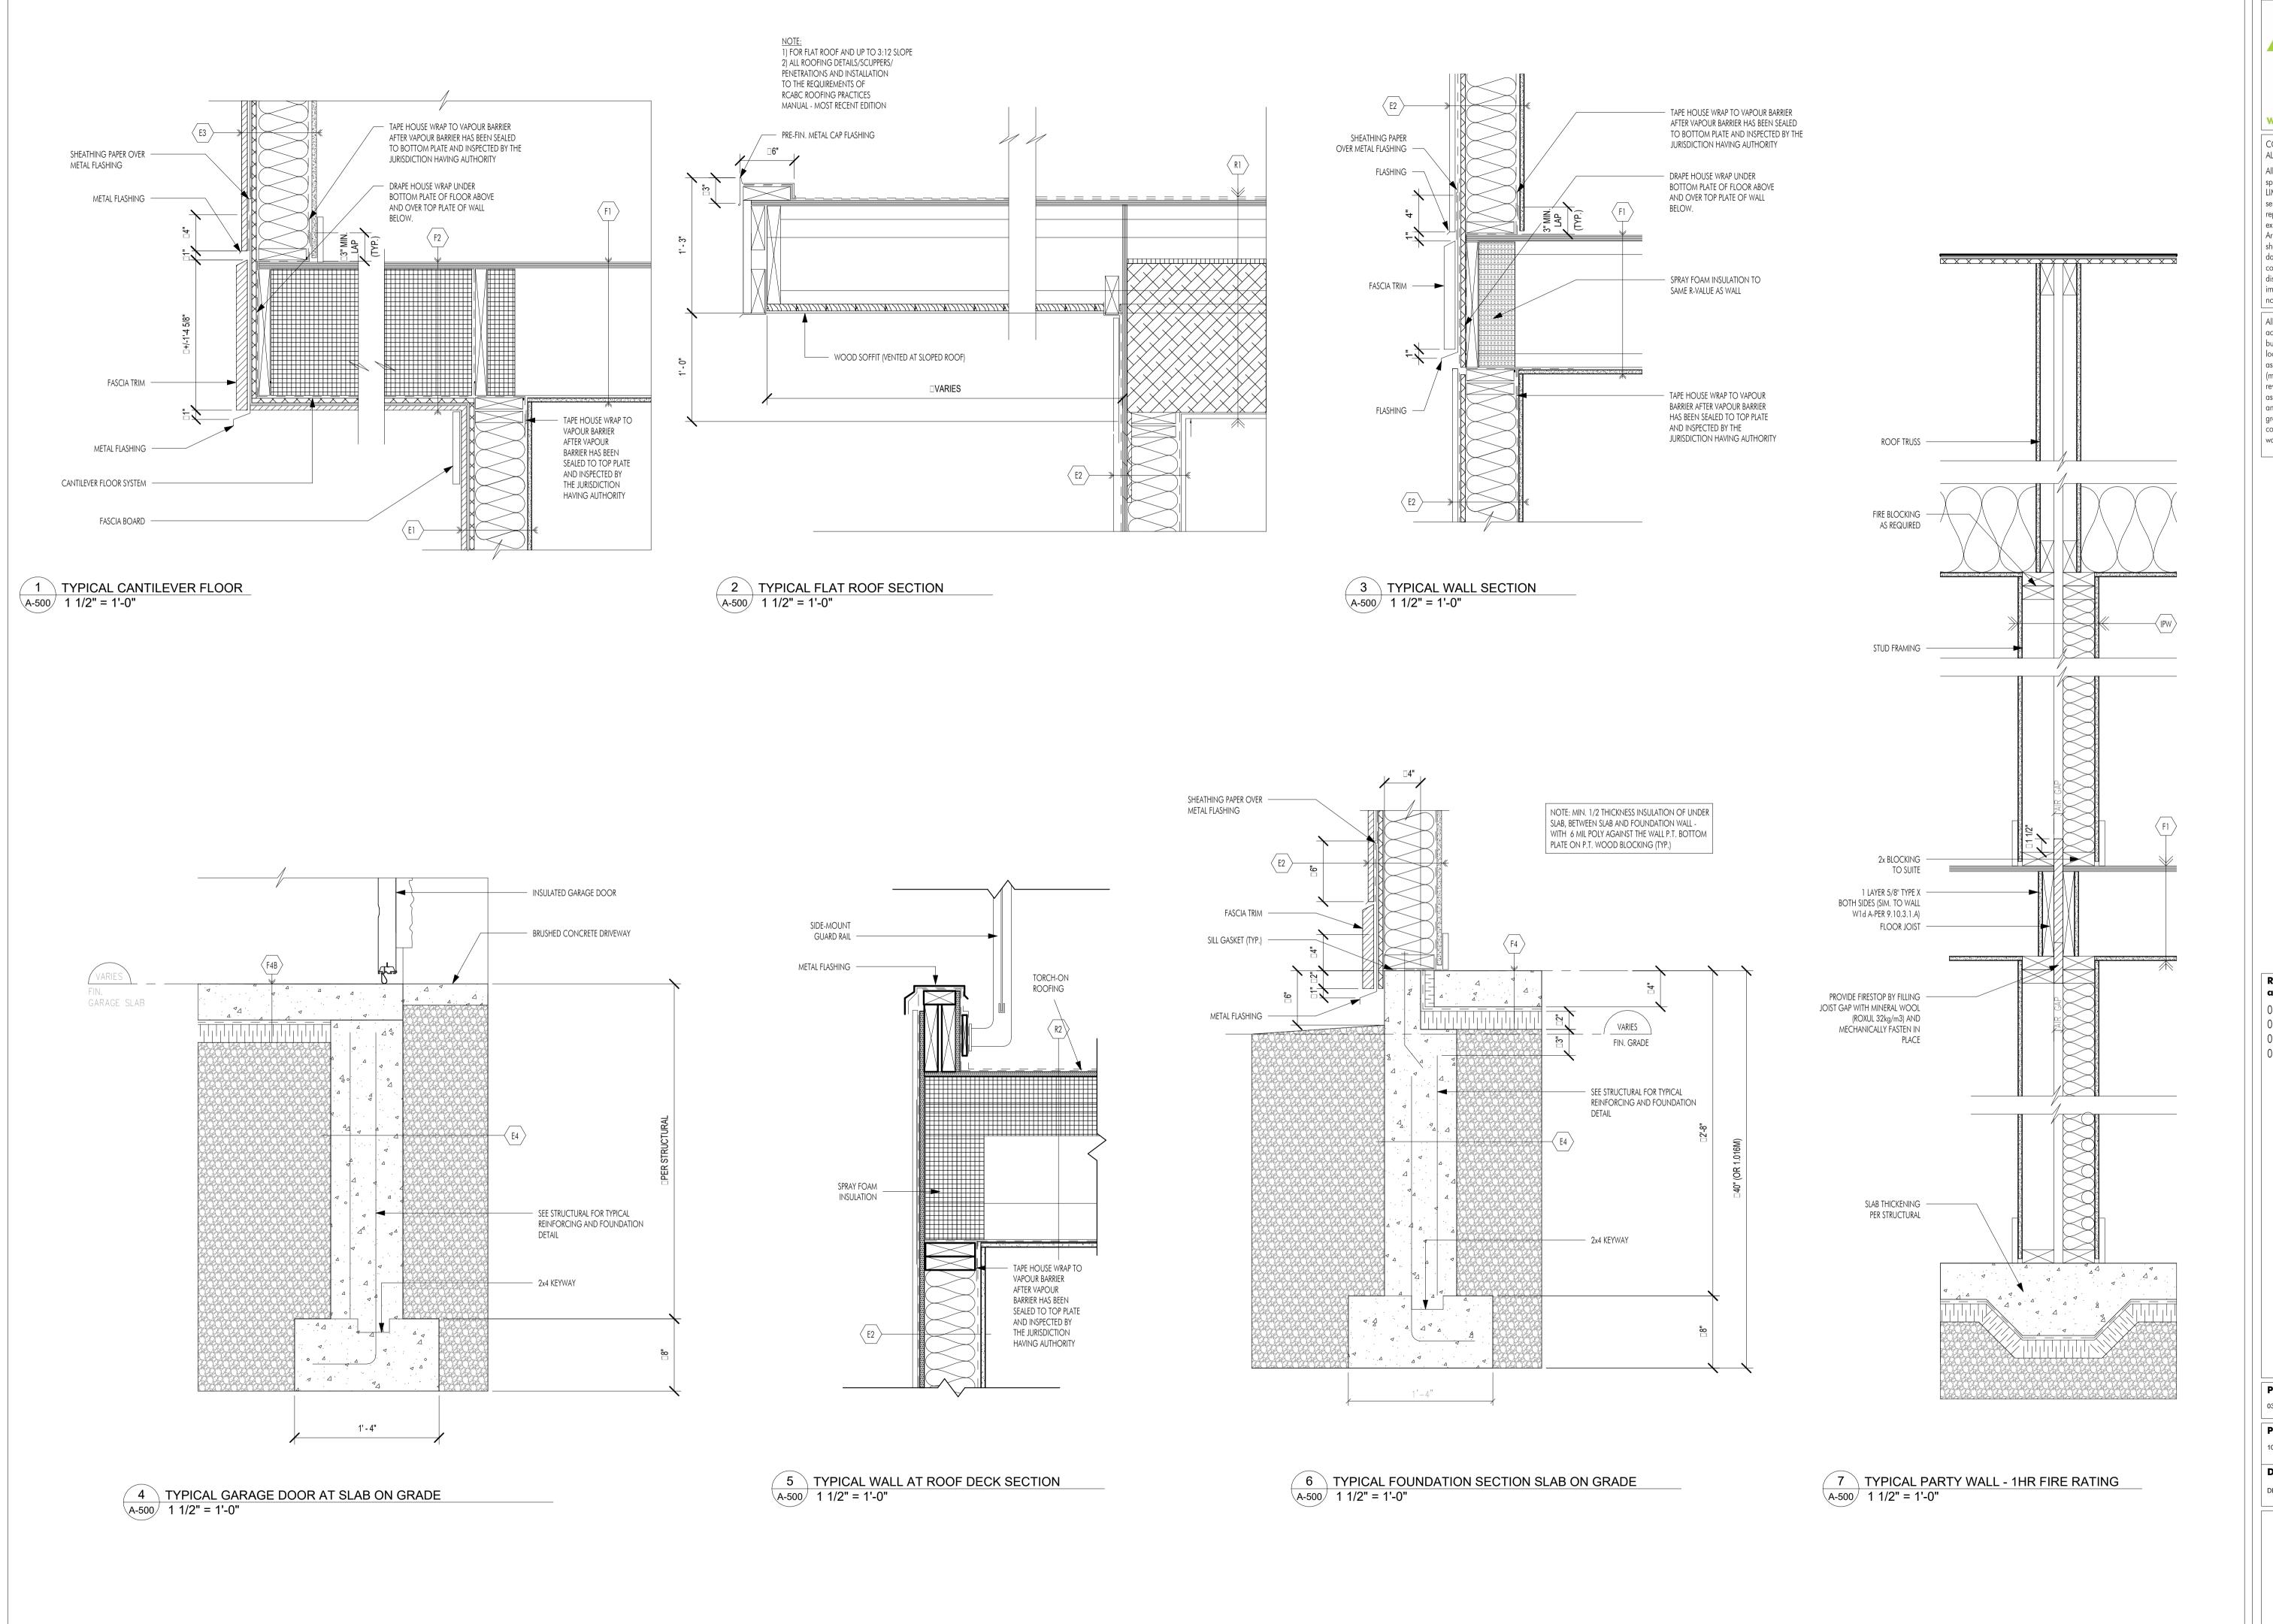

FOR DP/DVP

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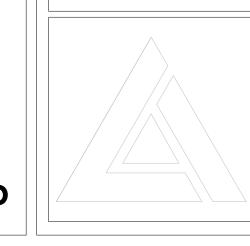
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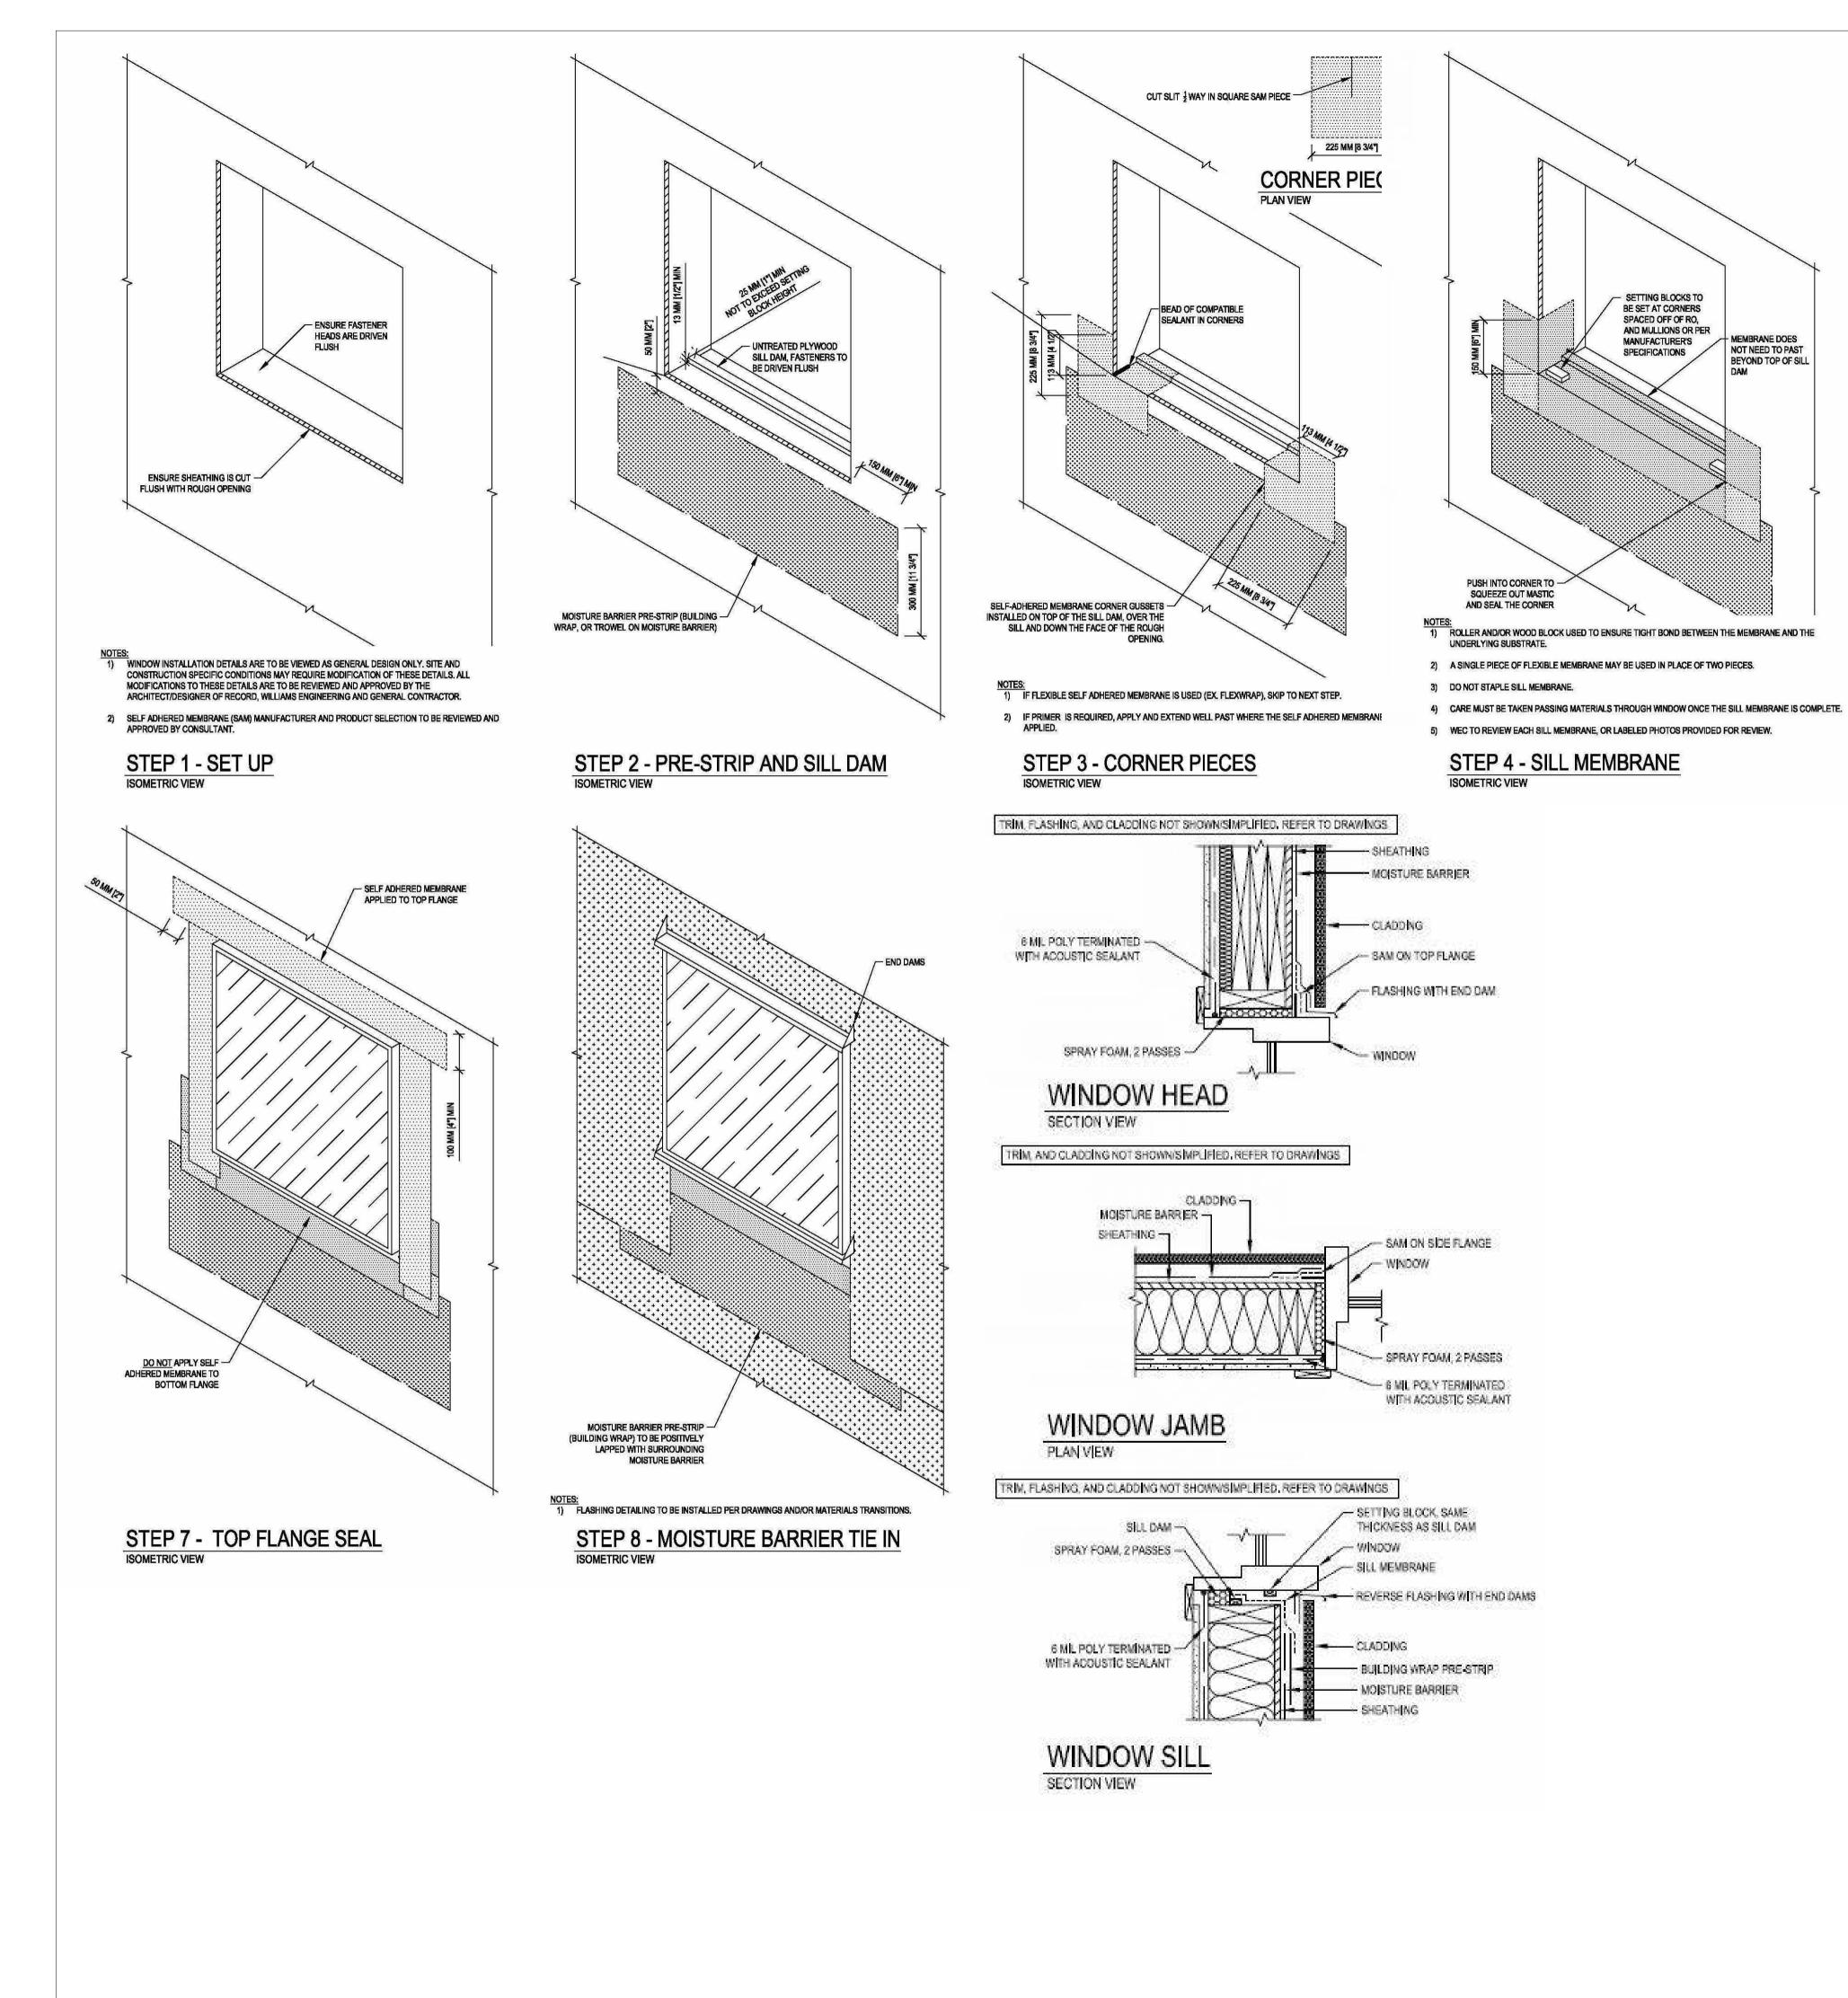
03.16.23


PROJECT

1010 MARTIN

DRAWING TITLE






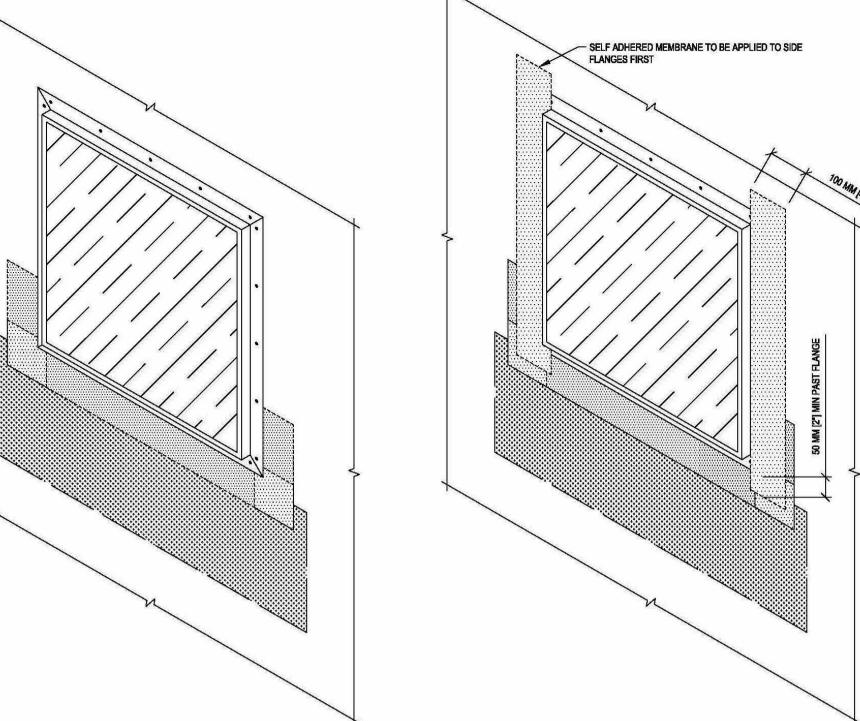

NOT NEED TO PAST BEYOND TOP OF SILL

STEP 5 - WINDOW INSTALLATION

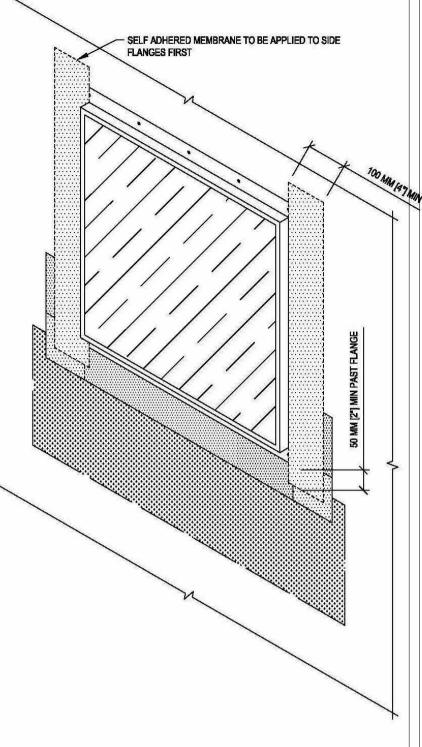

STEP 6 - SIDE FLANGE SEAL

Revision No., Date and Description

04.07.22 - FOR REVIEW 05.15.22 - FOR DP/BP 02.21.23 - FOR DP/BP 03.16.23 - FOR DP/DVP

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shall check and verify all levels, dimensions,

expressed written consent of LIME

Plot Date 03.16.23

PROJECT 1010 MARTIN

DRAWING TITLE

LOT 1 MARTIN AVE, KELOWNA BC

PROPERTY DESCRIPTION

CIVIC: 1010 MARTIN AVE, KELOWNA BC LEGAL: LOT 1, PLAN KAP6806

BC ENERGY STEP CODE COMPLIANCE: STEP 3


ZONING CALCULATIONS:

CURRENT: CITY OF KELOWNA MF1 ZONING

SITE INFORMATION:



	/ 051 05 /501 0\ W	ALLOWED	PROPOSED	
GROSS SITE AREA = ALLOWABLE SITE COVER ALLOWABLE SITE COVER F.A.R. =	, ,	55% (3,438.1 SF) 75% (4,688.3 SF) .8 (5,000.8 SF)	53% (3,303 SF) 72% (4,527 SF) .74 (4,648 SF)	
UNIT AREA CALCULATIO				
UNIT 1 ENTRY: UPPER:	599 SF 561 SF			
UNIT 2 ENTRY:	600 SF			
UPPER:	569 SF			
UNIT 3 ENTRY:	600 SF			
UPPER:	569 SF			
UNIT 4 ENTRY:	589 SF			
UPPER:	561 SF			
TOTAL:	4,648 SF			
		ALLOWED	PROPOSED	
HEIGHT=		8.0M (2 STOREYS)	7.2M (2 STOREYS)	
YARD SETBACKS:				
FRONT YARD=		4.0M	4.0M	
FLANKING STREET=		4.0M	2.0/4.0M -	VARIANCE
SIDE YARD=		1.2M	1.2M	REQUIRED
REAR YARD=		0.9M	0.9M	
PARKING CALCULATION	15:			
LESS THAN 5 DWELLING		1/DWELLING UNIT	4	
LONG-TERM BICYCLE ST	<u>TORAGE</u>			t
TOWNHOMES WITH PRI	VATE GARAGE =	4	4	CTDE
SHORT-TERM BICYCLE S	<u>TORAGE</u>			DAHAAA CTDEET
LESS THAN 5 DWELLING	UNITS =	0	0	٥

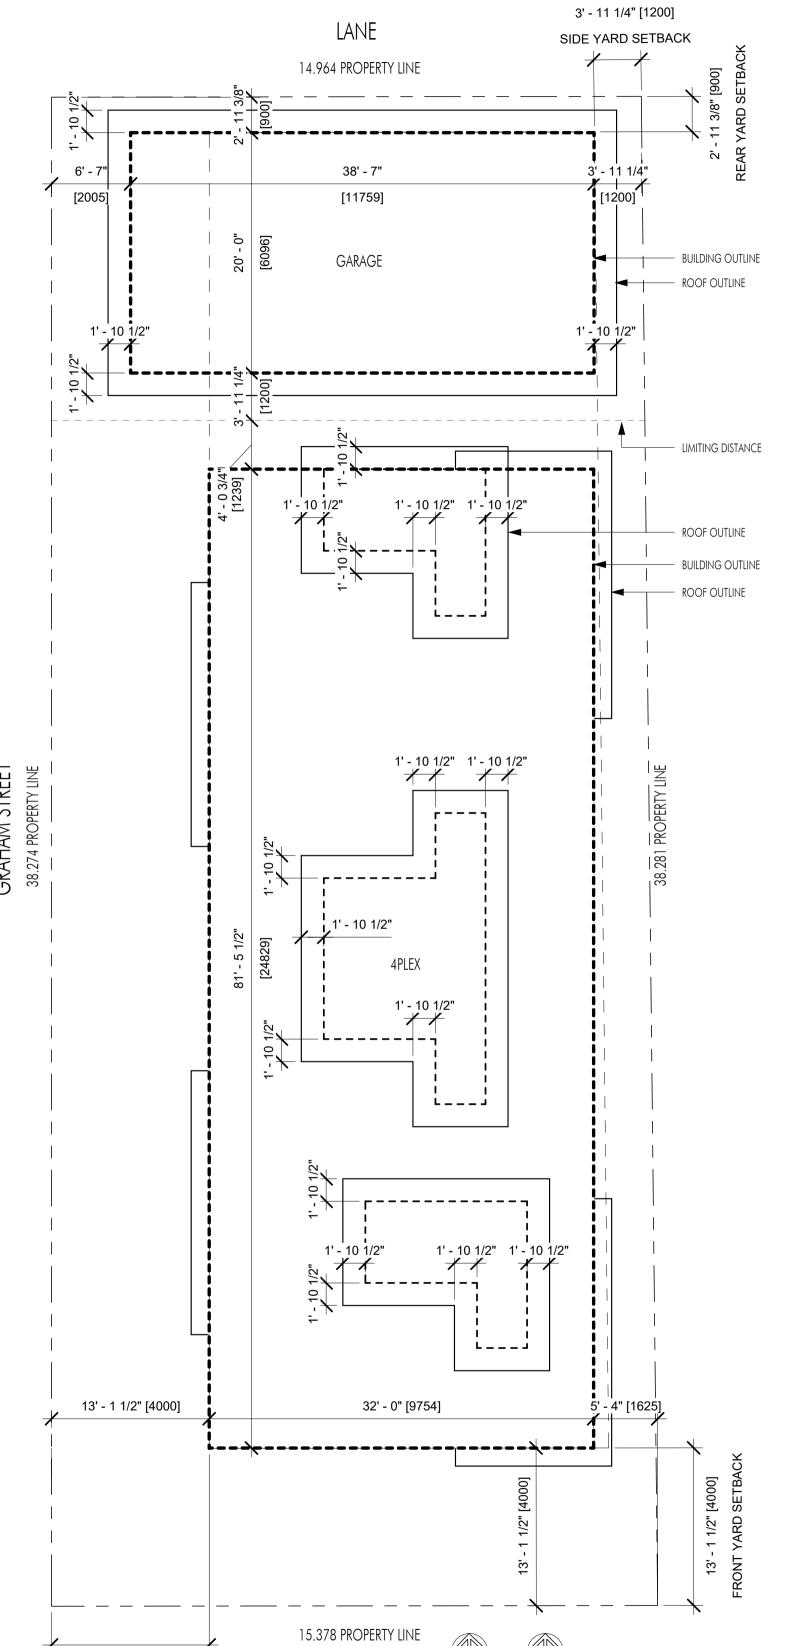

GENERAL NOTES - ARCHITECTURAL:

ALL WORK SHALL CONFORM TO THE STANDARDS OF THE N.B.C. OF CANADA 2015 (ALL APPLICABLE SECTIONS), THE B.C. BUILDING CODE (BCBC) 2018 AND ALL LOCAL CODES, BYLAWS AND AMENDMENTS.

-DO NOT SCALE DRAWINGS; DIMENSIONS ALWAYS TAKE PRECEDENCE.

-ALL TRADES SHALL VERIFY ALL DATUM'S, DIMENSIONS AND LEVELS PRIOR TO COMMENCEMENT OF WORK.

-ALL ERRORS AND OMISSIONS TO BE REPORTED IMMEDIATELY TO LIME ARCHITECTURE.

-VARIATIONS AND MODIFICATIONS TO THE WORK SHOWN ON DRAWINGS SHALL NOT BE CARRIED OUT WITHOUT THE EXPRESS WRITTEN PERMISSION OF LIME

-THESE DRAWINGS ARE THE EXCLUSIVE PROPERTY OF LIME ARCHITECTURE AND CANNOT BE REPRODUCED WITHOUT THE EXPRESSED WRITTEN PERMISSION OF LIME ARCHITECTURE.

-ALL WORK TO BE PERFORMED TO CURRENT GOOD TRADE PRACTICE STANDARDS BY WORKMEN SKILLED IN THEIR TRADES.

-ALL MATERIALS TO BE OF GOOD QUALITY, PROPERLY TRANSPORTED, STORED AND PROTECTED.

-ALL EXTERIOR DIMENSIONS TAKEN FROM OUTSIDE FACE OF WOOD STUDS AND EXTERIOR FACE OF CONCRETE UNLESS NOTED OTHERWISE.

-ALL INTERIOR DIMENSIONS TAKEN FROM CENTER LINE OF STUDS U.N.O.

-ALL LOAD BEARING LUMBER TO BE SPF #2 OR BETTER U.N.O. -ALL LOAD BEARING WOOD BEAMS TO BE SPF #2 OR BETTER U.N.O.

-ALL EXTERIOR WALLS TO BE 2 X 6 @ 24" O.C., U.N.O.

-INTERIOR WALLS TO BE 2 X 4 @ 24" O.C., U.N.O.; INTERIOR LOAD BEARING WALLS TO BE 2X6 @ 16" O.C., U.N.O. (SHOWN SHADED ON PLAN DRAWINGS)

-USE DOUBLE JOISTS UNDER PARTITIONS PARALLEL TO JOISTS UNLESS NOTED OTHERWISE (U.N.O.).

-ALL LOAD BEARING COLUMNS TO BE AT LEAST EQUAL TO WIDTH OF BEAMS AND OF SOLID LUMBER OR LAMINATED STUDS. -LINTELS UP TO 6'-0" WIDE TO BE 2-2 X 10 SPF #2 OR BETTER U.N.O. - TO BE BUILT UP TO EQUAL WIDTH OF WALL FRAMING.

-LINTELS OVER 6'-0" TO BE 2-2 X 12 SPF #1 OR BETTER OR ENGINEERED UNLESS NOTED OTHERWISE (U.N.O.).

-FRAMING TRADE TO PROVIDE MIN. 2 X 2 CROSS BRACING OR SOLID BLOCKING BETWEEN JOISTS AND RAFTERS @ 7'-0" O.C. MAXIMUM, MINIMUM ONE ROW UNLESS NOTED OTHERWISE BY FLOORING ENGINEER.

-ALL FOOTINGS TO BEAR ON UNDISTURBED NATIVE SOIL, APPROVED ENGINEERED FILL OR BEDROCK AND EXTEND A MINIMUM DEPTH 300MM BELOW FROST LINE

FROM FINISHED GRADE

-MINIMUM CONCRETE STRENGTH AT 28 DAYS: FOOTINGS, SLABS, FOUNDATION WALLS: 3000PSI, LIGHTWEIGHT CONCRETE TOPPING: 4000PSI. -MINIMUM PAD FOOTING SIZES AS PER STRUCTURAL NOTES BELOW AND/OR AS NOTED ON PLAN DRAWINGS (LARGEST PAD AND REINFORCING SIZES TO TAKE

PRECEDENCE WHERE CONTRADICTION EXISTS).

-SECURE SILL PLATES TO FOUNDATION WALLS WITH 1/2" DIAM. X 10" ANCHOR BOLT @ 4'-0" O.C. FOR EXTERIOR WALLS AND 6'-0" FOR INTERIOR WALLS. -ALL WOOD MEMBERS IN CONTACT WITH CONCRETE TO BE PROTECTED WITH SILL PLATE GASKET.

-PROVIDE DAMPROOFING TO ALL EXTERIOR FOUNDATION WALLS (INCLUDING RE-DAMPROOFING) IN ACCORDANCE WITH BCBC 2018.

-PROVIDE A MINIMUM OF 6" CLEARANCE BETWEEN SOIL AND ANY WOOD MEMBERS.

-ALLOWABLE SOIL BEARING PRESSURE 2000 PSF ASSUMED FOR DESIGN AND TO BE CONFIRMED AT EXCAVATION BY A QUALIFIED ENGINEER.

-PROVIDE ALUMINUM FLASHINGS OVER ALL EXTERIOR OPENINGS.

-CAULK AND SEAL ALL EXTERIOR OPENINGS IN ACCORDANCE WITH BCBC 2018.

-VENTILATION REQUIREMENTS TO CONFORM TO BCBC 9.32.3 AND TABLE 9.32.3.5. -UNIFORMLY DISTRIBUTE VENTILATION TO ROOFS AS PER BCBC 9.19.1.2.

-PROVIDE A MINIMUM CLEARANCE BETWEEN TOP OF ROOF INSULATION AND UNDERSIDE OF ROOF SHEATHING AS PER BCBC 9.19.1.3.

-DWELLING GLAZING SECURITY REQUIREMENTS TO CONFORM TO BCBC 9.7.6 AND APPENDIX (A)9.7.5.3.(1).

-ALL EXTERIOR AND REQUIRED GUARDS TO BE 3'-6" (1070MM) HIGH WITH MAX. 3.9" (100MM) CLEAR OPENINGS.

-ALL HANDRAILS SHALL BE A MINIMUM 2'-8" HIGH ABOVE THE NOSINGS. -ALL STAIR TREADS TO BE 10 1/2 INCH MINIMUM AND AN 1/2 " NOSING.

-ALARMS AND DETECTION SYSTEMS TO BE AS PER 3.2.4.1 OF THE BCBC.

ARCHITECTURAL DRAWINGS


A-001 PROJECT INFORMATION

A-002 ASSEMBLIES

A-104 GARAGE PLAN

13' - 1 1/2" [4000]

FLANKING STREET SETBACK

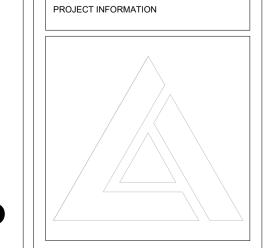

Drawing No.

Plot Date

PROJECT

1010 MARTIN

DRAWING TITLE

03.16.23

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shall check and verify all levels, dimensions data and conditions on the site prior to commencement of any work. Any discrepancies are to be reported immediately to LIME Architecture Inc. Do not Scale any dimensions from this drawing

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building by-laws and requirements of other local authorities having jurisdiction as well as the british columbia building code -

(most recent edition) including all published revisions and addenda. All trades shall assume full responsiblity for the locations and protection of all under and above ground utilities, wires and conduit connections, including (but not limited to)

water, sewer, gas, hydro and telephone.

Revision No., Date and Description 04.07.22 - FOR REVIEW

05.15.22 - FOR DP/BP 02.21.23 - FOR DP/BP

03.16.23 - FOR DP/DVP

FOR DP/DVP

TRUE NORTH PROJECT NORTH

Kelowna:

Heating Days >3000, <4000 = Zone 5 Minimum RSI Values Required (with HRV):

Ceilings below attics = 6.91
Cathedral ceilings/flat roofs = 4.67
Walls = 2.97
Floors over unheated spaces = 4.67

Basement Walls= 2.98
Unheated floor below frost line= uninsulated
Unheated floor above frost line= 1.96
Heated floors= 2.32

RSI Parallel = 100

Marea of framing + Marea of cavity RSIc

WALL TY	<u> </u>	T			RSI _F RSI _C	
TYPE NO.	COMPONENTS		COMPONENT RSI	COMPONENT EFFECTIVE RSI		TOTAL EFFECTIV RSI
E1	EXTERIOR WALL STUCCO	EXTERIOR AIR FILM STUCCO FINISH COAT (1/8", 3mm MIN.) STUCCO SCRATCH COAT ON METAL LATH (2 COATS, 1/4", 6mm MIN. EACH) 15 LBS BUILDING PAPER 1/2" SHEATHING (PLYWOOD OR OSB) 2x6" WOOD STUDS @ 24" O.C STANDARD FRAMING R-24 BATT INSULATION (CAN/ULC-S702) 6mil POLY V.B. 1/2" GYPSUM BOARD (PAINTED) INTERIOR AIR FILM	(.03) (.0027) (.0108) (.109) (1.19) - 20% INSULATED STUD ASSEMBLY (4.23) - 80% INSULATED STUD ASSEMBLY - (.08) (.12)	(.03) (.014) (.109) (3.62) (.08) (.12)	+/-71/8"	3.97
E2	EXTERIOR WALL HARDIE	EXTERIOR AIR FILM HARDIE FIBRE CEMENT SIDING (5/16", 8mm) 15 LBS BUILDING PAPER 1/2" SHEATHING (PLYWOOD OR OSB) 2x6" WOOD STUDS @ 24" O.C STANDARD FRAMING R-24 BATT INSULATION (CAN/ULC-S702) 6mil POLY V.B. 1/2" GYPSUM BOARD (PAINTED) INTERIOR AIR FILM	(.03) (.003/mm) (.109) (1.19) - 20% INSULATED STUD ASSEMBLY (4.23) - 80% INSULATED STUD ASSEMBLY (.08) (.12)	(.03) (.026) (.109) (3.62) (.08) (.12)	+/- 6 3/4"	3.99
E2B	EXTERIOR WALL FIBRE CEMENT (NON-INSULATED)	EXTERIOR AIR FILM FIBRE CEMENT SIDING (5/16", 8mm) 15 LBS BUILDING PAPER 1/2" SHEATHING (PLYWOOD OR OSB) 2x6" WOOD STUDS @ 24" O.C STANDARD FRAMING 6mil POLY V.B. 1/2" GYPSUM BOARD (PAINTED) INTERIOR AIR FILM			+/- 6 5/8" +/- 6 5/8"	
E3	EXTERIOR WALL BRICK VENEER	EXTERIOR AIR FILM FINISH AS INDICATED ON DWGS (1 1/2" CULTURED STONE) 15 LBS BUILDING PAPER (SHINGLED AS PER CODE) 1/2" SHEATHING (PLYWOOD OR OSB) 2x6" WOOD STUDS @ 24" O.C STANDARD FRAMING R-24 INSULATION 6mil POLY V.B. 1/2" GYPSUM BOARD (PAINTED) INTERIOR AIR FILM	(.03) (0.0003/mm) (.109) (1.19) - 20% INSULATED STUD ASSEMBLY (4.23) - 80% INSULATED STUD ASSEMBLY (.08) (.12)	(.03) (0.011) (.109) (3.62) - (.08) (.12)	+/- 81/2"	3.97
E4	EXTERIOR FOUNDATION (UNINSULATED)	8" (203mm) C.I.P. CONCRETE (SEE STRUCTURAL)				
E5	EXTERIOR FOUNDATION (UNINSULATED)	6" (152mm) C.I.P. CONCRETE (SEE STRUCTURAL)				
<u></u>	INTERIOR WALL	2X4 WOOD STUDS SPACED 24" O.C. 1/2" GYPSUM BOARD EACH SIDE			<u> </u>	
(12)	INTERIOR WALL (LOADBEARING AND PLUMBING)	2X6 WOOD STUDS SPACED 16" O.C. 1/2" GYPSUM BOARD EACH SIDE			6 1/2"	
(IPW)	1 HR BEARING 1 HR NON-BEARING STC: 54 (BCBC WALL TYPE: W13c A-9.10.3.1.A)	TWO ROWS 2X4 WOOD STUDS ON SEPARATE 2X4 PLATES (PLATES SET 1" APART), STUDS SPACED @ 16" O.C. (24" MAX - STUDS TO ALIGN ON ALL THREE LEVELS) 3-1/2" THICK ABSORPTIVE MATERIAL ONE SIDE 1 LAYER 5/8" TYPE 'X' GYPSUM BOARD EACH SIDE (NOTE: CUT GYPSUM BOARD TO FIT TO U/S ROOF SHEATHING AND FILL 1/4" NOMINAL GAP WITH ACOUSTICAL SEALANT)				

FLOOR TYPES

TYPE NO.	COMPONENTS		COMPONENT	COMPONENT EFFECTIVE RSI		TOTAL EFFECTIVE RSI
F1	INTERIOR ENG. WOOD FLOORING SYSTEM (NON-INSULATED)	FINISH FLOORING ENGINEERED WOOD FLOOR (SEE STRUCTURAL) 5/8" GYPSUM BOARD (PAINTED)			PRE ENG. +-/-1'-11/4"	
F2	INTERIOR ENG. WOOD FLOORING SYSTEM (EXTERIOR PROJECTION)	INTERIOR AIR FILM FINISH FLOORING 3/4" T&G PLYWOOD FLOORING 6 MIL. POLY ENGINEERED WOOD FLOOR (SEE STRUCTURAL) R-31 MIN. CLOSED CELL SPRAY FOAM INSULATION NON-VENTED SOFFIT EXTERIOR AIR FILM	(.16) (.16) (2.05) - 9% INSULATED FLOOR ASSEMBLY (5.46) - 91% INSULATED FLOOR ASSEMBLY (.03)	(.16) (.16) - (5.15) (.03)	PRE ENG.	5.5
F3	CONCRETE SLAB ON GRADE	INTERIOR AIR FILM 4" CONC. SLAB (SEE STRUCTURAL) (2400 kg/m3) STEEL REINFORCING (SEE STRUCTURAL) 6 MIL. POLY 2" EXTRUDED POLYSTYRENE (XPS) (AT SLAB ON GRADE TO EXTEND 48" MIN. INTO BUILDING FROM PERIMETER EDGE) FILL (AS PER CIVIL AND ARCHITECTURAL GENERAL NOTES) UNDISTURBED SOLID BEARING	(.16) (.04) (1.76)	(.16) (.04) (1.76)	#	1.96
F4	CONCRETE SLAB ON GRADE (NON-INSULATED)	4" CONC. SLAB (SEE STRUCTURAL) (2400 kg/m3) STEEL REINFORCING (SEE STRUCTURAL) 6 MIL. POLY FILL (AS PER CIVIL AND ARCHITECTURAL GENERAL NOTES) UNDISTURBED SOLID BEARING			g	

ROOF TYPES

TYPE NO.	COMPONENTS		COMPONENT RSI	COMPONENT EFFECTIVE RSI	TOTAL EFFECTIVE RSI
RI	TYPICAL FLAT ROOF ASSEMBLY	EXTERIOR AIR FILM 2 PLY. MOD. BIT ROOFING SYSTEM PER RCABC 7/16" OSB SHEATHING VENTED AIR SPACE 24" ENG. ROOF TRUSSES (CEILING WITH TYPICAL TRUSS) (CONFIRM WITH STRUCTURAL) 14" BLOWN CELLULOSIC INSULATION (TO CAN/ULC-S703) 6mil POLY V.B. 1/2" GYPSUM BOARD (PAINTED) INTERIOR AIR FILM	(.03) (NEG) (NEG) (.76) - 14% INSULATED TRUSS ASSEMBLY (8.89) - 86% INSULATED TRUSS ASSEMBLY (.08) (.11)	(.03) (7.75) (.08) (.11)	2% MIN. SLOPE
⟨R2⟩	TYPICAL ROOF DECK ASSEMBLY	EXTERIOR AIR FILM PAVER PAV-EL PEDESTAL (SHIM TO ACHIEVE LEVEL FINISHED FACE) 2 PLY. MOD. BIT ROOFING SYSTEM PER RCABC 7/16" ASPHALT IMPREGNATED FIBREBOARD (PER RCABC) SHEATHING AIR SPACE 24" ENG. ROOF TRUSSES (CEILING WITH TYPICAL TRUSS) (CONFIRM WITH STRUCTURAL) 14" BLOWN CELLULOSIC INSULATION (TO CAN/ULC-S703) 6mil POLY V.B. 1/2" GYPSUM BOARD (PAINTED) INTERIOR AIR FILM	(.03) (NEG) (.76) - 14% INSULATED TRUSS ASSEMBLY (8.89) - 86% INSULATED TRUSS ASSEMBLY - (.08) (.11)	(.03) (.03) (.7.75) (.08) (.11)	7.97
R3	TYPICAL SLOPED ROOF ASSEMBLY (UNINSULATED)	EXTERIOR AIR FILM ASPHALT SHINGLES 15 LBS BUILDING PAPER (SHINGLED AS PER CODE) 7/16" OSB SHEATHING VENTED AIR SPACE 24" ENG. ROOF TRUSSES (CEILING WITH TYPICAL TRUSS) (CONFIRM WITH STRUCTURAL) 20" BLOWN CELLULOSIC INSULATION (TO CAN/ULC-S703) 6mil POLY V.B. 1/2" GYPSUM BOARD (PAINTED) INTERIOR AIR FILM			PRE ENG. +/- 2' - 1 1/4" CONFIRM ON SITE

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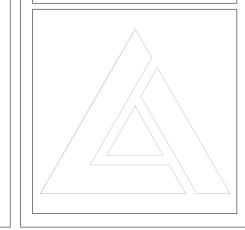
Revision No., Date and Description 04.07.22 - FOR REVIEW 05.15.22 - FOR DP/BP 02.21.23 - FOR DP/BP


03.16.23 - FOR DP/DVP

lot Date Drawing No.
16.23 A-002


PROJECT
1010 MARTIN

DRAWING TITLE
ASSEMBLIES



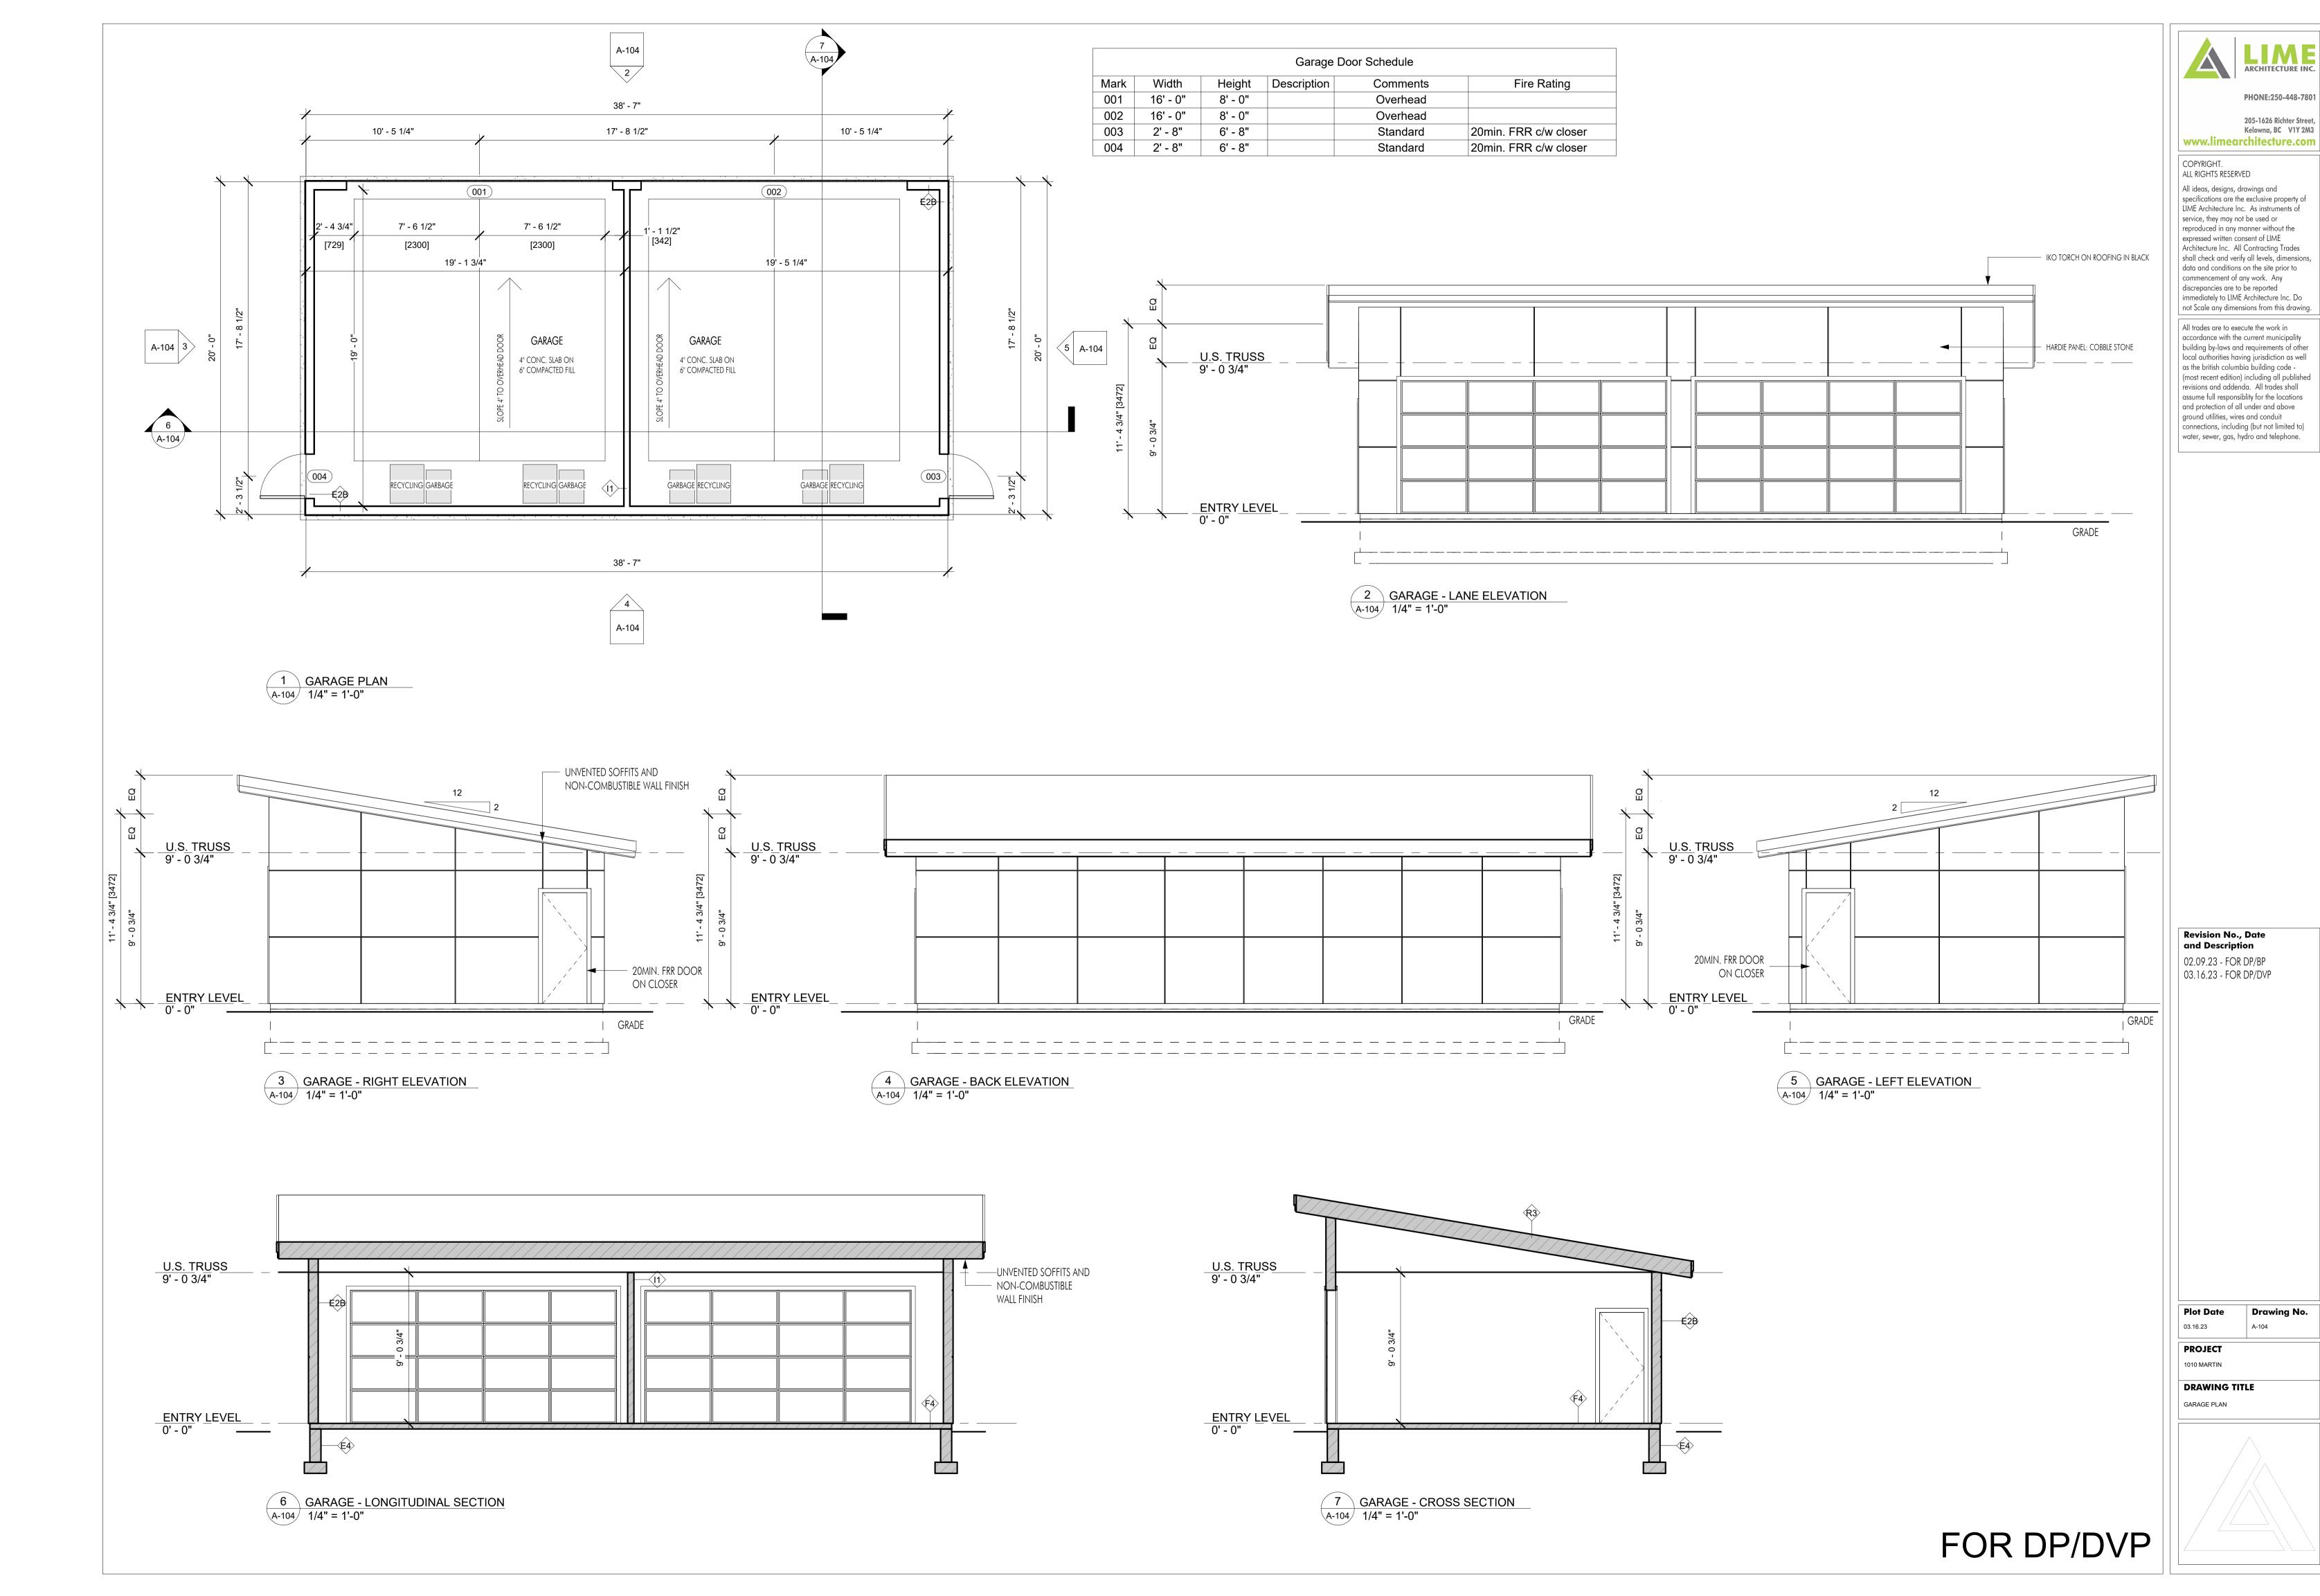

LANE

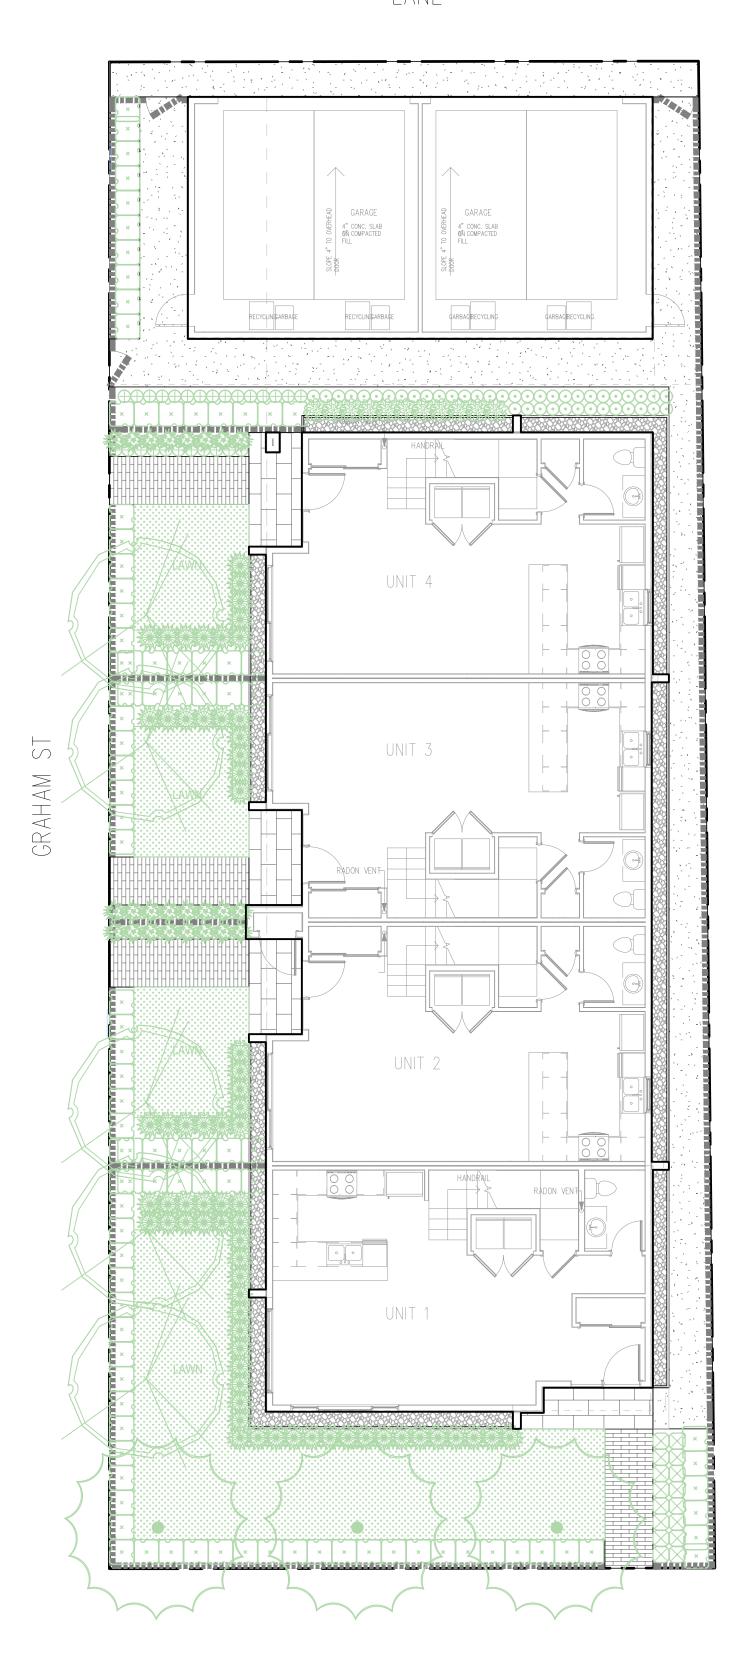


GENERAL NOTES:

- 1. ALL PLANTING SHALL BE IN ACCORDANCE WITH BC LANDSCAPE STANDARD, LATEST EDITION.
- 2. ALL PLANTING AREAS TO RECEIVE AUTOMATIC DRIP IRRIGATION, WITH TIME CLOCK AND RAIN SENSOR, FOR FIRST YEAR OF PLANTING MATERIAL ESTABLISHMENT.
- 3. ALL LANDSCAPE ARCHITECTURAL DRAWINGS IN THIS PACKAGE SHALL BE READ IN CONJUNCTIONS, AND ANY OTHER CORRESPONDANCE THAT MAY BE ISSUED DURING THE COURSE OF THE CONTRACT.
- 4. IF A DISCREPANCY OCCURS BETWEEN THE DRAWINGS AND THE SPECIFICATIONS OR ANY OTHER DOCUMENT ASSOCIATED WITH THE PROJECT, THE CONFLICT SHALL BE REPORTED IN WRITING TO THE LANDSCAPE ARCHITECT TO OBTAIN CLARIFICATION AND APPROVAL BEFORE PROCEEDING WORKS.
- 5. ALL EXISTING INFORMATION IS BASED ON AVAILABLE RECORDS AND SHALL NOT BE CONSTRUED TO BE COMPLETE OR ACCURATE.
- 6. THE CONTRACTOR SHALL VISIT THE SITE TO VERIFY THE TRUE EXISTING CONDITIONS. ANY UNCLEAR ISSUE SHALL BE CLARIFIED WITH THE CONSULTANT TEAM. NO CLAIM SHALL BE ALLOWED FOR EXTRA WHICH MAY ARISE THROUGH NEGLECT OF THIS ADVICE.
- 7. THE CONTRACTOR IS RESPONSIBLE FOR DETERMINING THE EXISTENCE, LOCATION, AND ELEVATION OF UTILITIES AND CONCEALED STRUCTURES, AND IS RESPONSIBLE FOR NOTIFYING THE APPROPRIATE COMPANY, DEPARTMENT OR PERSON(S) OF ITS INTENTION TO CARRY OUT ITS OPERATION.
- 8. LAYOUT OF PAVING MATERIALS IS TO BE STAKED OUT AND APPROVED BY THE LANDSCAPE ARCHITECT PRIOR TO INSTALLATION.

Klimo & Associates

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Contact: 604.358-5562
Email: klimofrancis@gmail.com

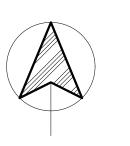

2 FEB 24, 2023 REVISED AS PER COMMENTS

1 JUL 15, 2022 ISSUED FOR REVIEW

NO DATE DESCRIPTION

REVISIONS

PROJECT:

1010 MARTIN AVENUE

1010 MARTIN AVENUE, KELOWNA BC.

SCALE: \frac{1}{8}"


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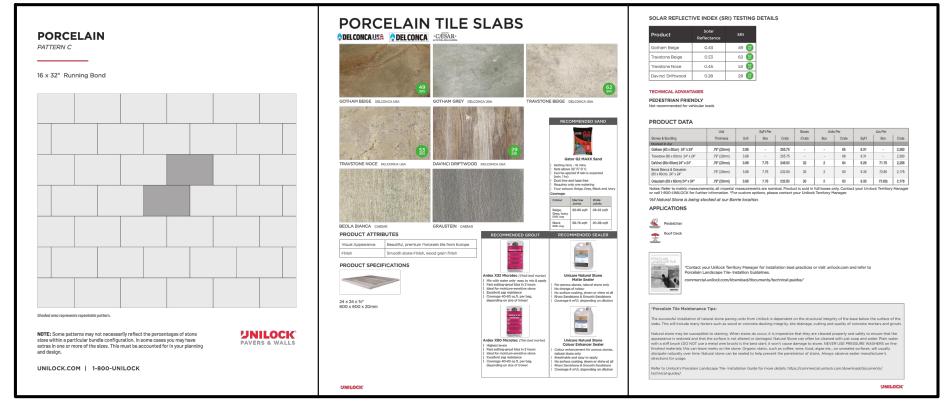
REVIEWED:

DRAWING:


OVERALL LANDSCAPE PLAN

LANE




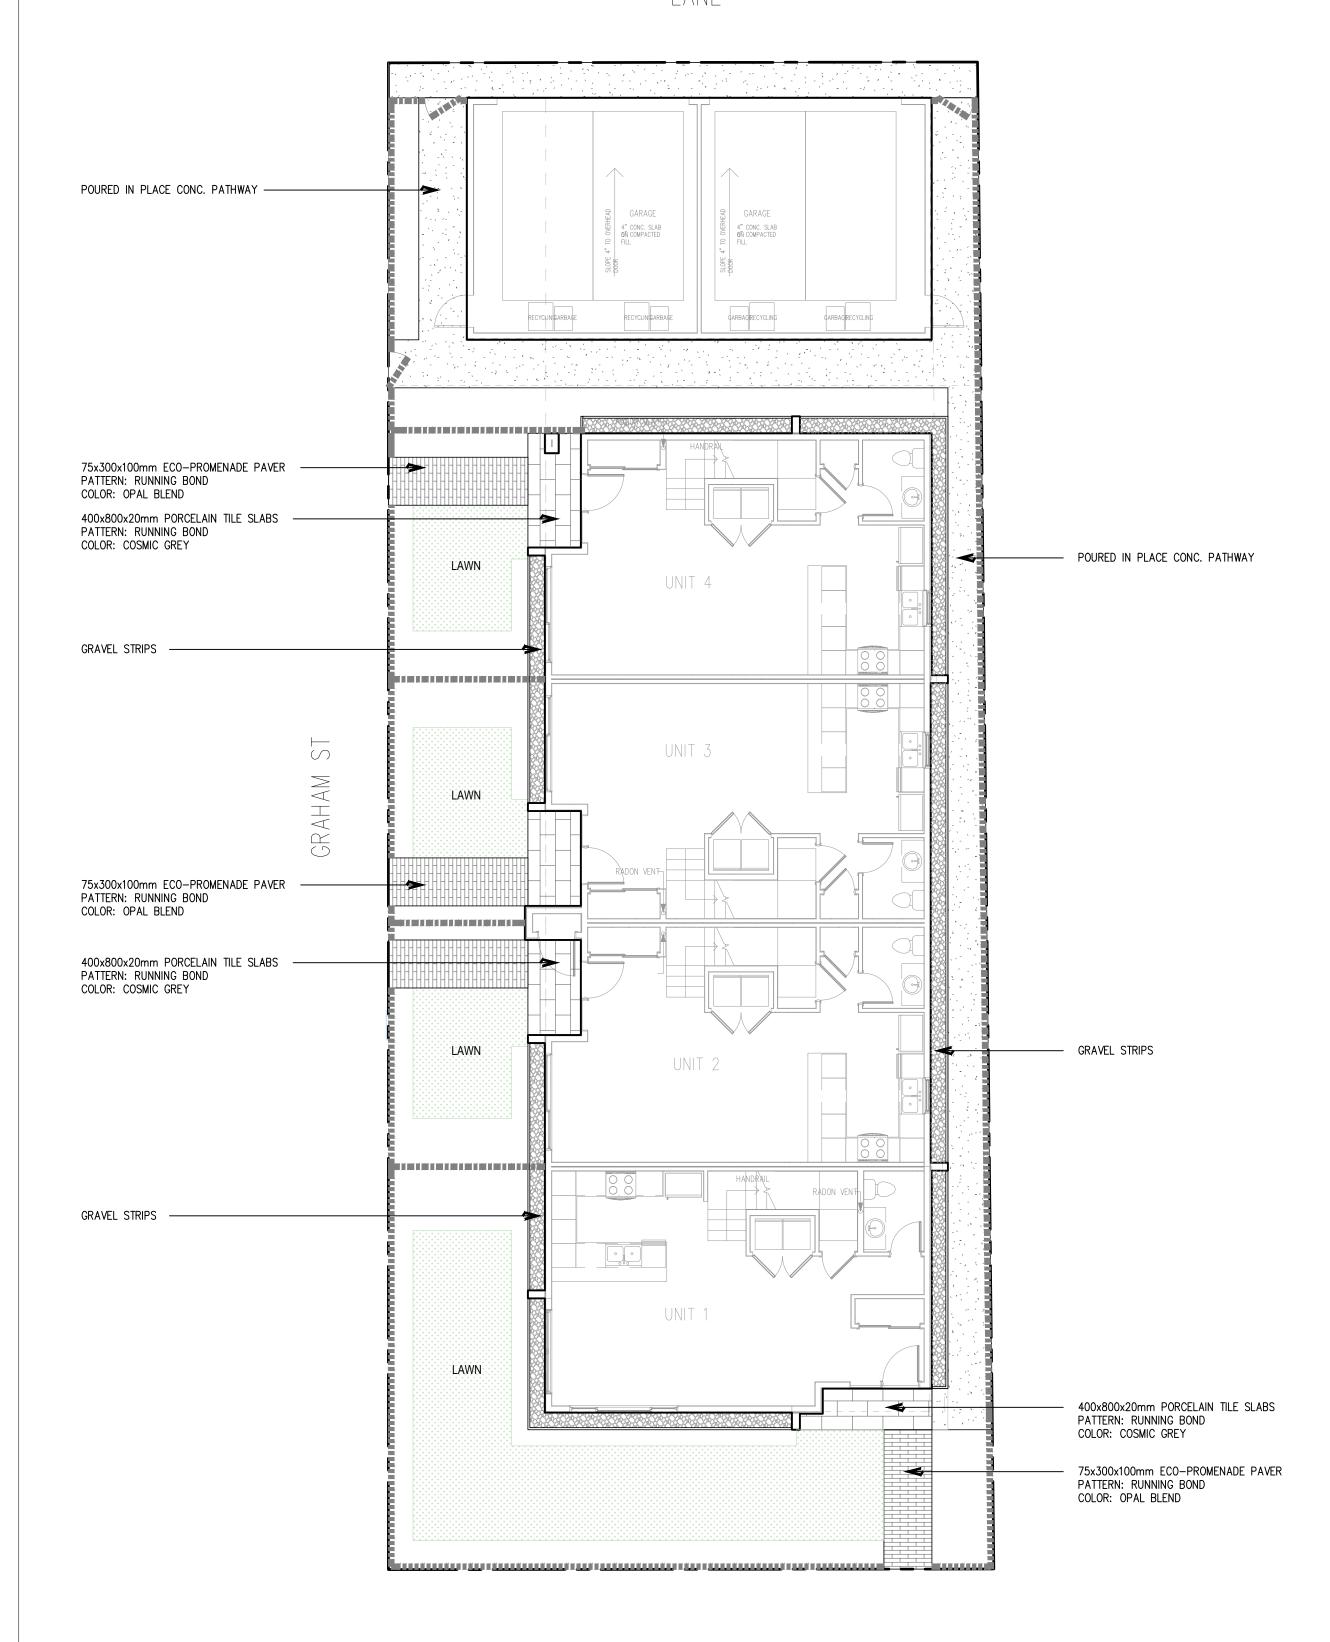


DELCONCA-PORCELAIN TILE SLABS
UNILOCK - 400MMX800MM 20MM - COSMIC GREY

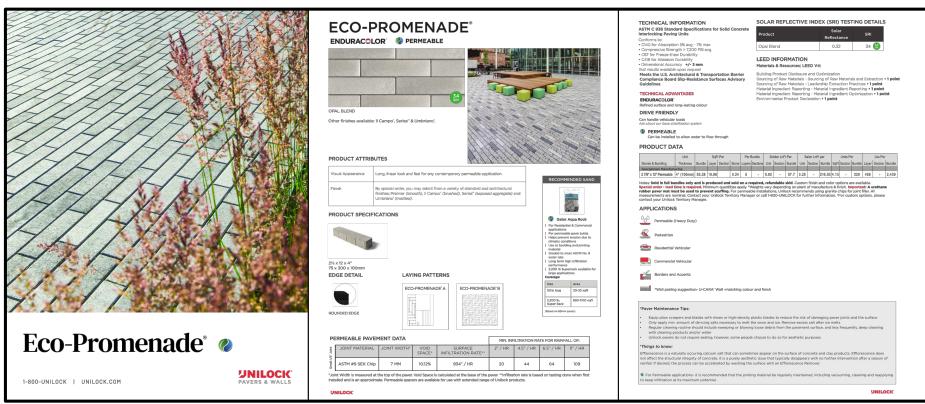

ECO-PROMENADE PERMEABLE PAVERS
UNILOCK - 75MMX300MM 100MM - OPAL BLEND

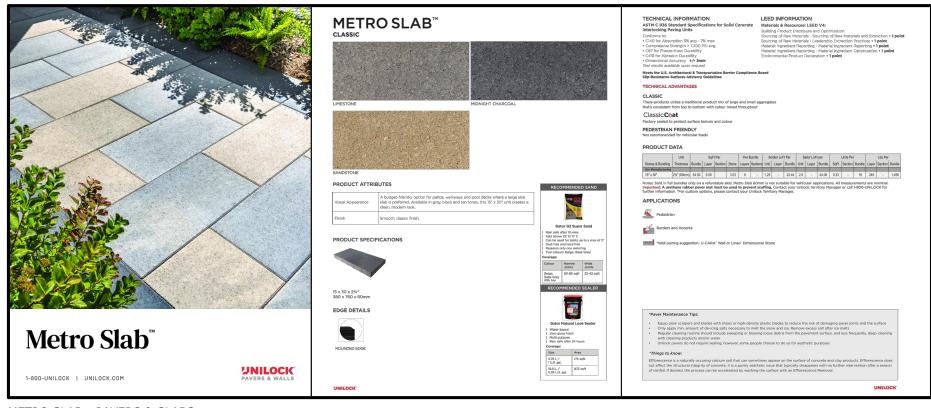


METRO SLAB - PAVERS & SLABS UNILOCK - 380X760X60MM - LIMESTONE

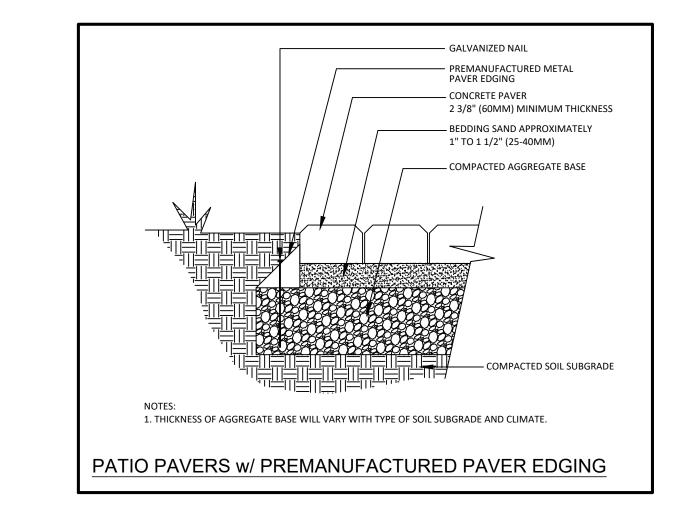

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1010 MARTIN AVENUE, KELOWNA BC.


SCALE:	1 " - 1
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DRAWING:	

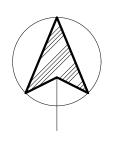MATERIALS PLAN

DRAWING NUMBER:


11 (

LANE 6'HT CEDAR FENCE — GARBAGRECYCLING GARBAGRECYCLING 4'HT CEDAR FENCE — LAWN \vdash — 6'HT CEDAR FENCE 6'HT CEDAR FENCE ----LAWN LAWN 4'HT CEDAR FENCE ----— 4'HT CEDAR FENCE

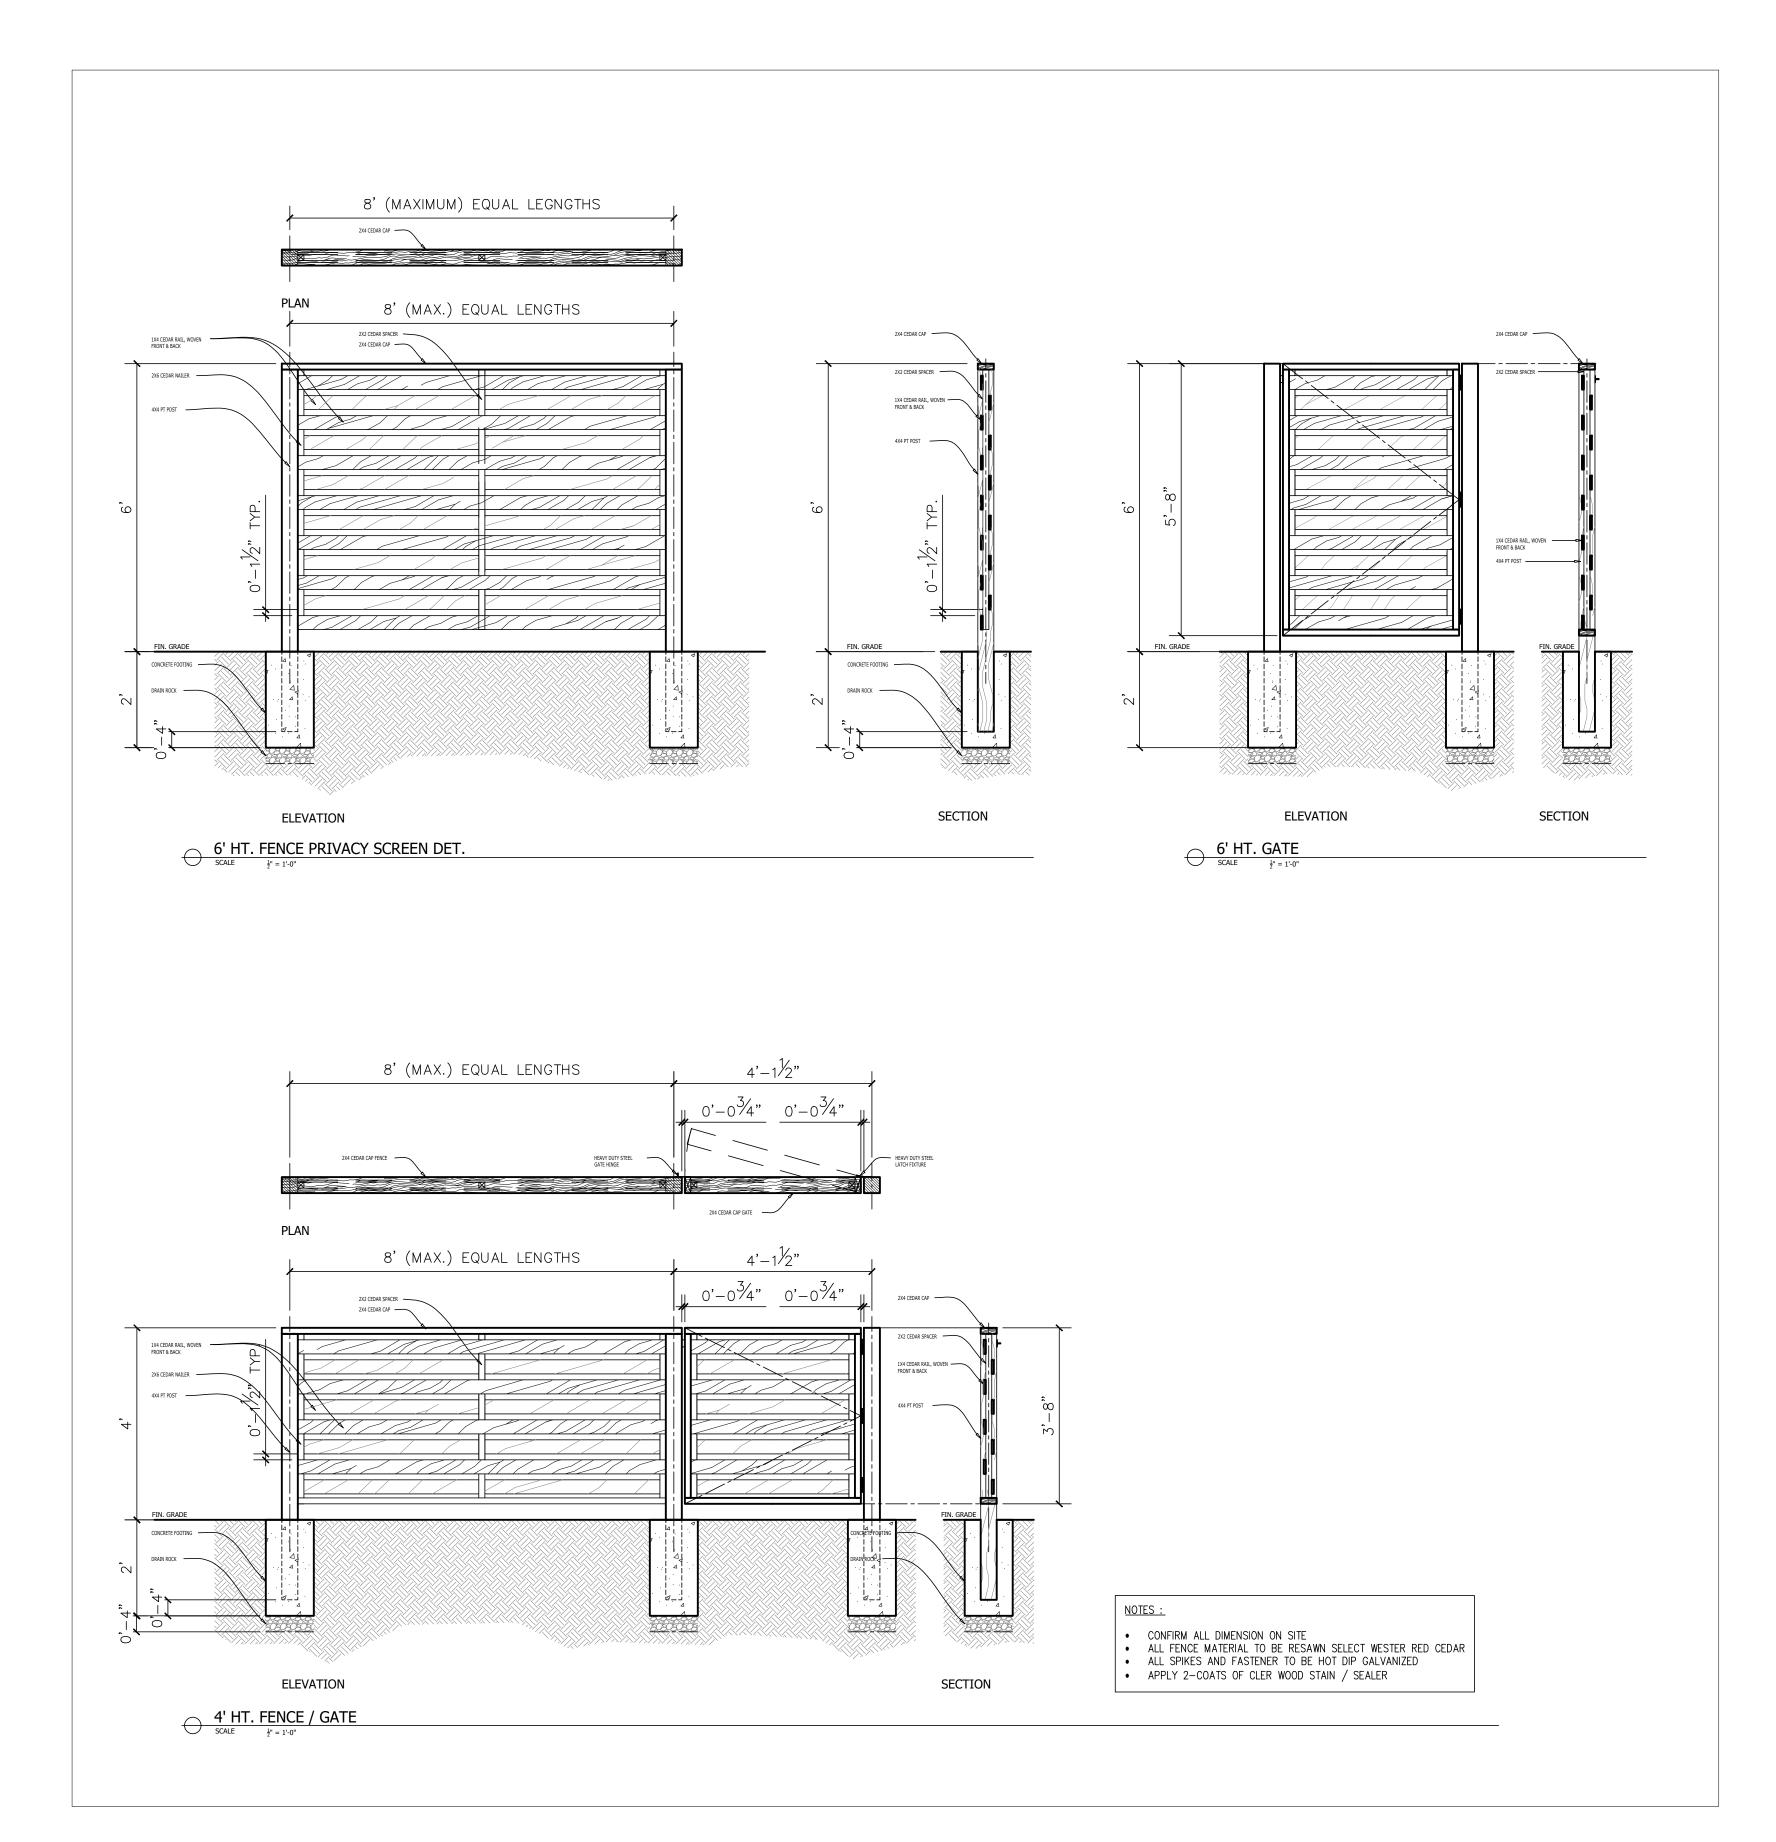

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1010 MARTIN AVENUE

REVISIONS
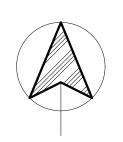
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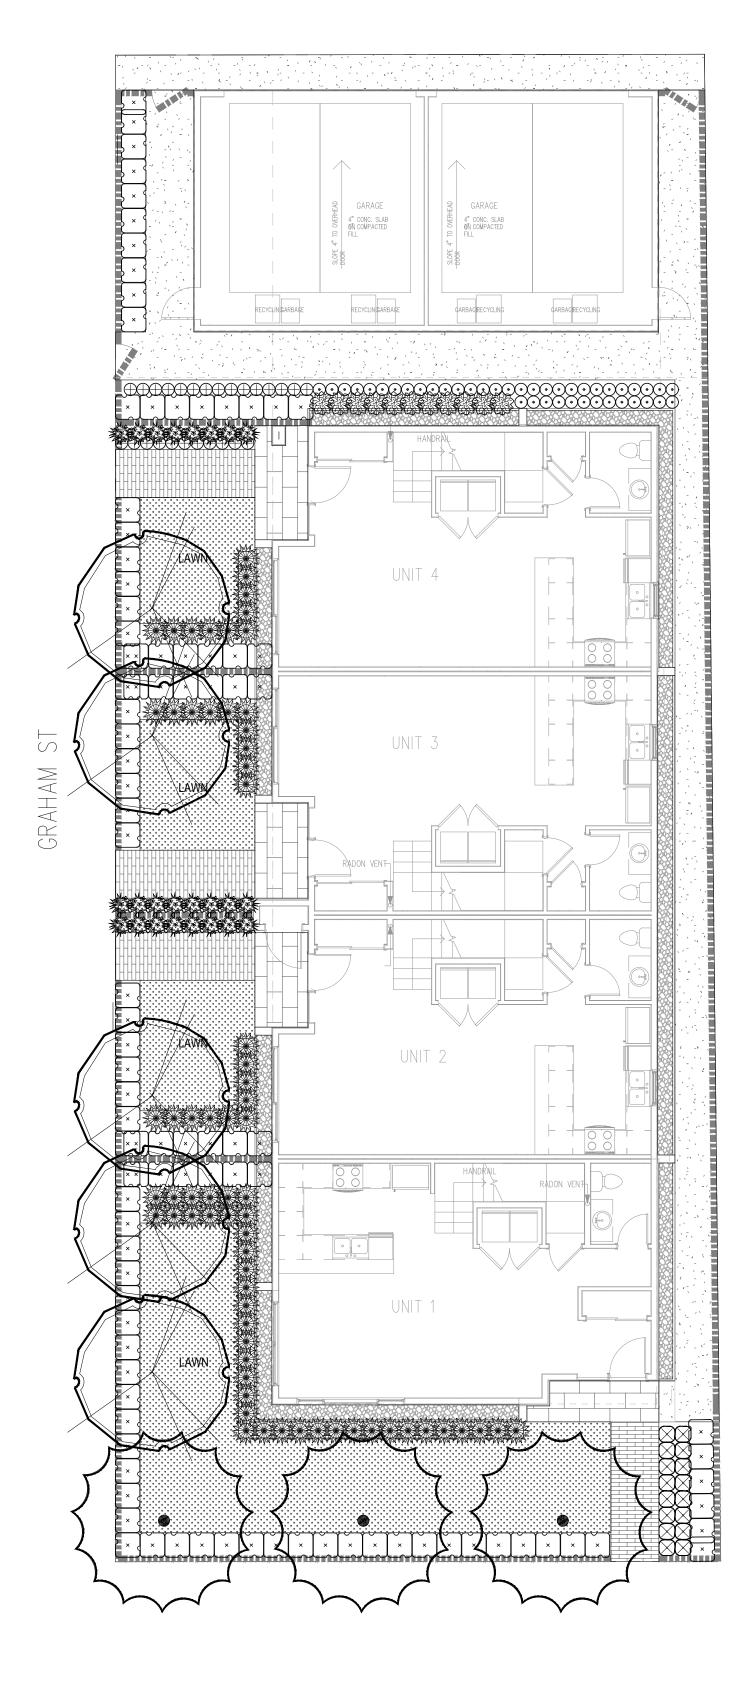
SCALE:	<u>1</u> " - 1'0"
DRAWN:	EDS
REVIEWED:	FK
DRAWING:	

PERIMETER/PRIVACY FENCE PLAN


DRAWING NUMBER:

I 1

LANE



PLANT LIST

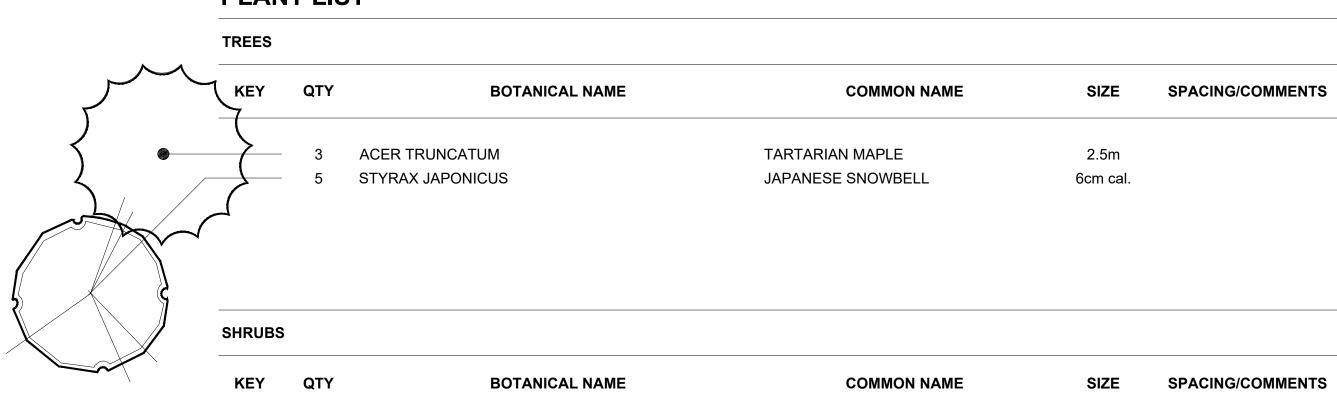

KEY	QTY	BOTANICAL NAME	COMMON NAME	SIZE	SPACING/COMMENTS
GROUND (COVER	/ PERENNIALS			
	98	TAXUS x MEDIA 'HICKSII'	HICKSII YEW	1.2m	@ 24" o.c.


EDGING BOXWOOD
HINO WHITE AZALEA

CHINESE ASTILBE

BLUE HOSTA

ENGLISH LAVENDER

JAPANESE SPURGE

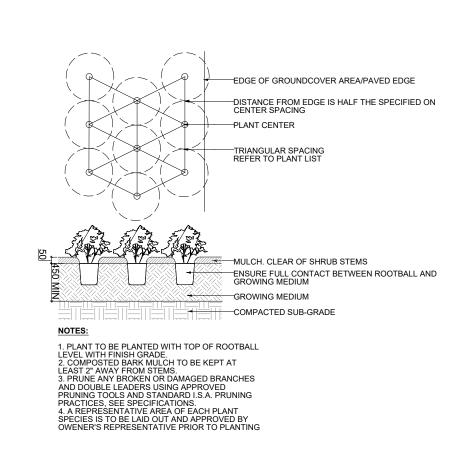

BUXUS SEMPERVIRENS 'SUFFRUTICOSA'

ASTILBE CHINENSIS 'VISION IN WHITE'


LAVANDULA ANGUSTIFOLIA


12 HOSTA SEIBOLDIANA 'ELEGANS'

⊕ 30 PACHYSANDRA TERMINALIS

AZALEA JAPONICA 'HINO WHITE'

1 GROUNDCOVER PLANTING - SCALE: NTS

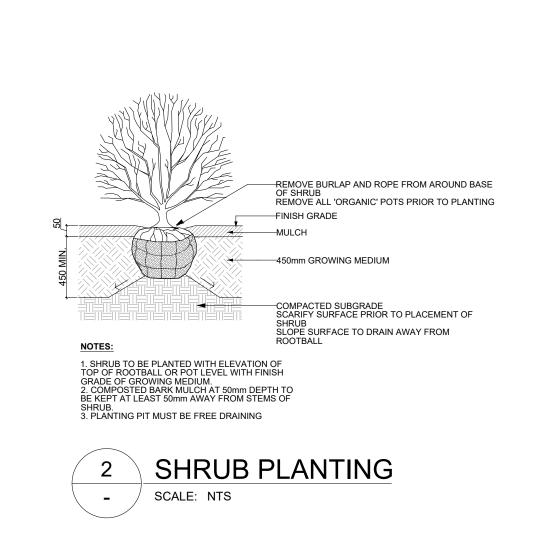

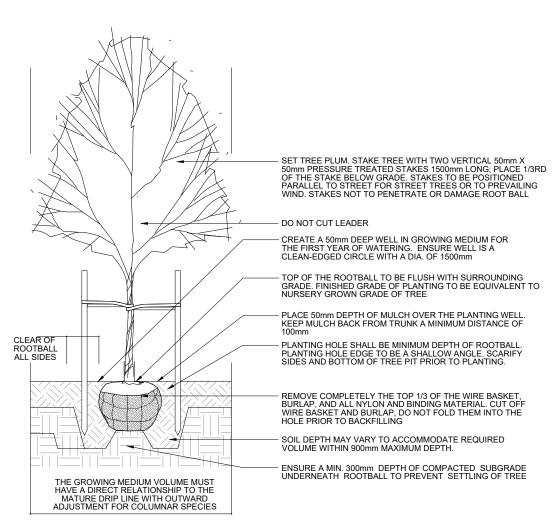

2 pot

2 pot

2 pot

1 pot

1 pot

1 pot

@ 24" o.c.

@ 24" o.c.

@ 24" o.c.

@ 16" o.c.


@ 16" o.c.


@ 12" o.c.

3 TREE PLANTING
- SCALE: NTS

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PROJECT:

1010 MARTIN AVENUE

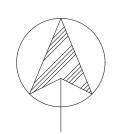1010 MARTIN AVENUE, KELOWNA BC.

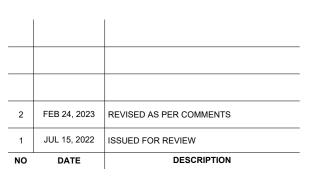SCALE: \$\frac{1}{8}\cdot - 1'0''\$

DRAWN: EDS

REVIEWED: FK


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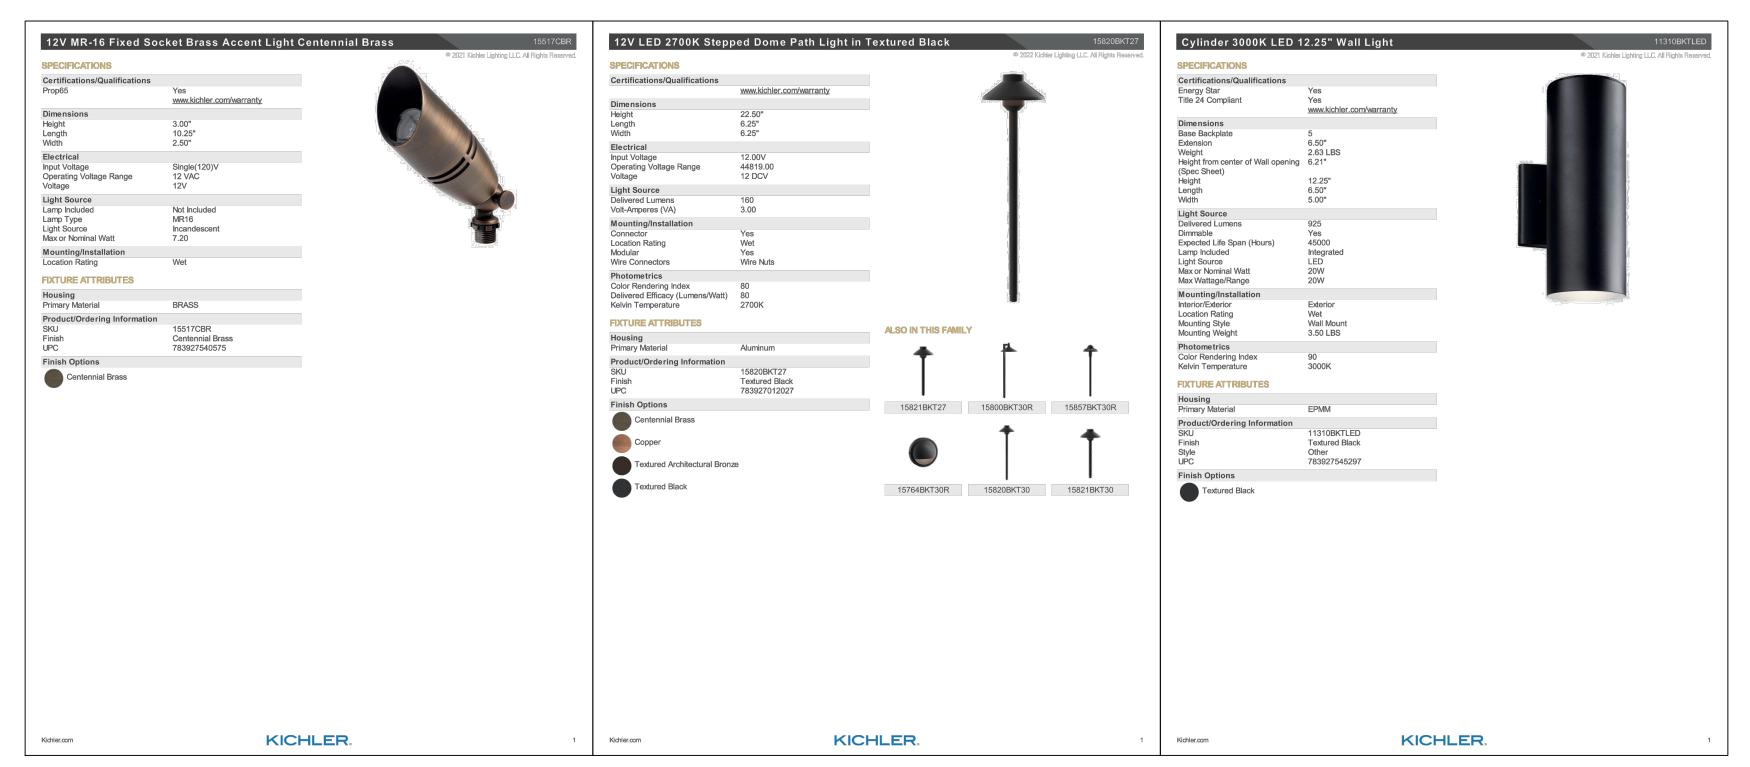
PLANTING PLAN

DRAWING NUMBER:


L2.0

LANE



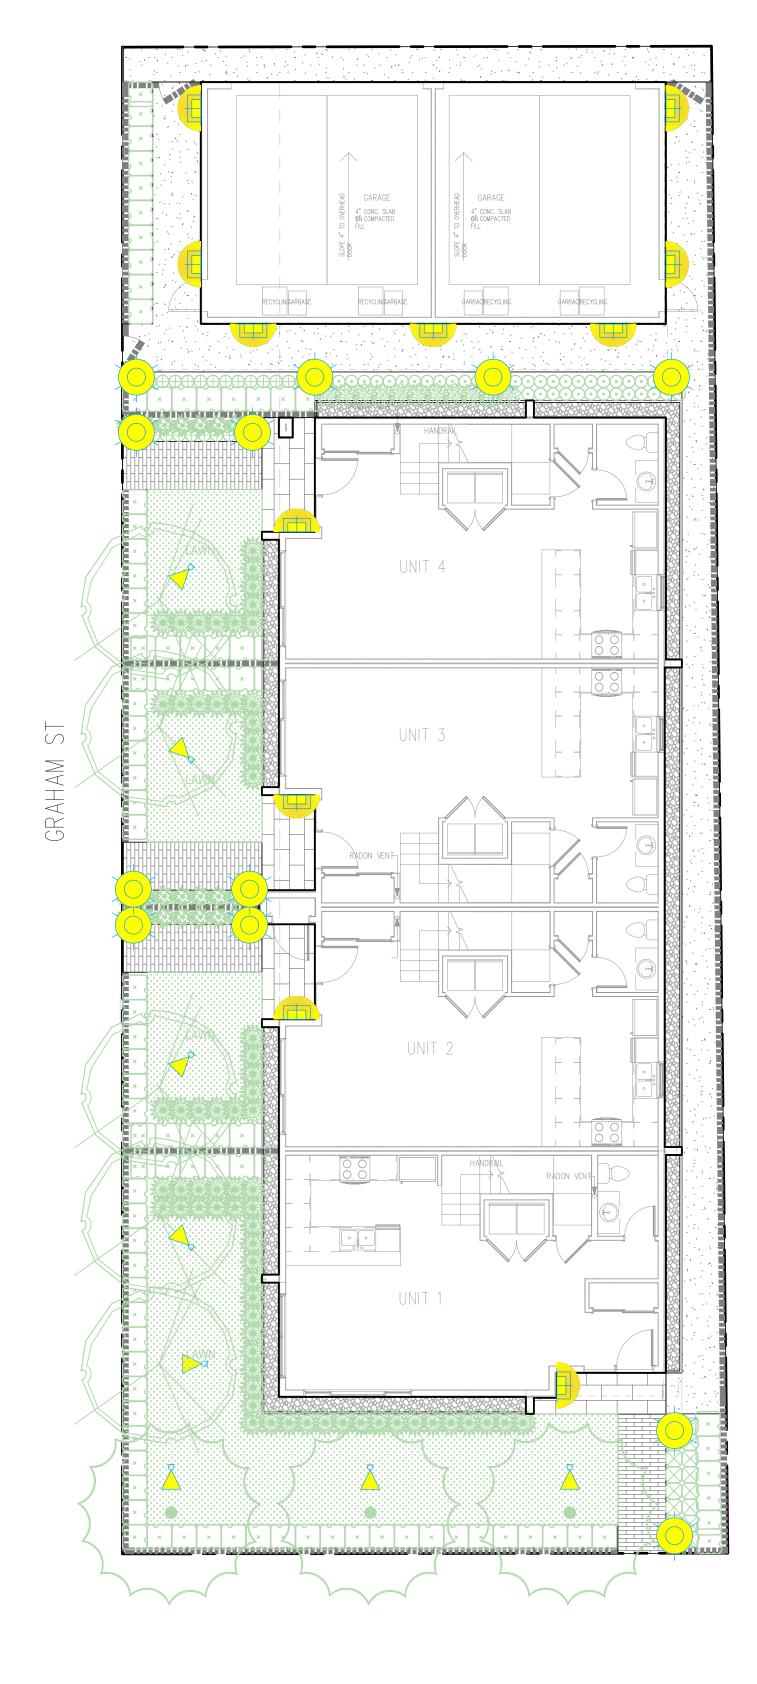

<u>UPLIGHT</u> <u>SCONCE</u>

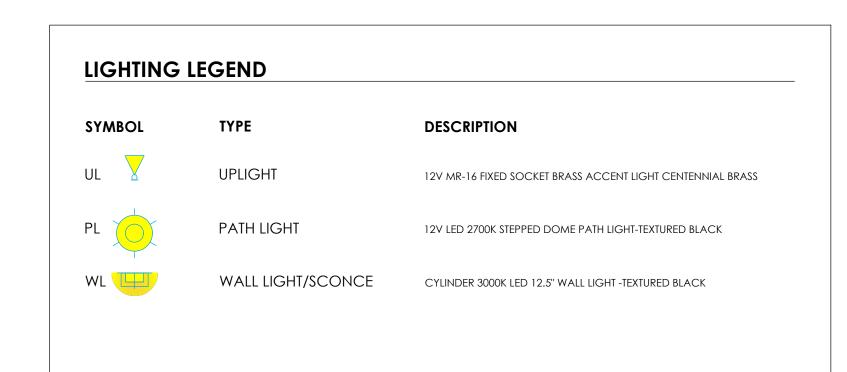

LIGHTING NOTES:

- COORDINATE ALL WIRING WITH ARCHITECTURAL PLANS, ALL PLACEMENT AND ADJUSTMENT OF LIGHTS TO BE DETERMINED ON
 SITE
- ALL ELECTRICAL TO COMPLY WITH THE LATEST BC BUILDING CODE, CONTRACTOR TO ACQUIRE ANY NECESSARY PERMITS REQUIRED
- REQUIRED

 ALL PERMANENTLY INSTALLED OUTDOOR LIGHTING SHALL BE CONTROLLED BY A PHOTOCONTROL OR ASTRONOMICAL TIME
- SWITCH THAT AUTOMATICALLY TURNS OFF THE OUTDOOR LIGHTING WHEN DAYLIGHT IS AVAILABLE


 CONTRACTOR TO COORDINATE THE PLACEMENT OF SLEEVES FOR WIRING PRIOR TO TO ANY HARDSCAPING, SLEEVING TO BE
- SCHEDULE 40 AND OF A DEPTH TO MEET CURRENT ELECTRICAL STANDARDS

 CONTRACTOR TO FLAG, VERIFY AND CONFIRM LOCATIONS OF ANY UTILITIES THAT MAY CONFLICT WITH LIGHTING PRIOR TO
- COMMENCEMENT OF WORK

 CONDUIT LAYOUT BY ELECTRICAL CONTRACTOR

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PROJECT:

1010 MARTIN AVENUE

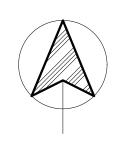1010 MARTIN AVENUE, KELOWNA BC.

 SCALE:
 \frac{1}{8}" - 1'0"

 DRAWN:
 EDS

 REVIEWED:
 FK

 DRAWING:
 FK

LIGHTING PLAN

DRAWING NUMBER:

13(

ALL MEASUREMENTS TO BE PROVIDED IN METRIC.

Site Context				
Future Land Use (2040 OCP)		C-NHD		
Transit Supported Corridor?	No (y/n)			
Subdivision/Consolidation required?	No (y/n)			
Adjacent Land Uses:	Adjacent Zone		Adjacent Use	
North	MF1			
South	RU4			
East	MF1			
West	P2			
Site Details	Zone Requireme	ent	Proposal	
Site Area		m²	581	m²
Site Width		m	14.964 / 15.378	m
Site Depth		m	38.274 / 38.281	m
Site Coverage of building(s)	55	%	53	%
Site Coverage of buildings & impermeable surfaces	75	%	72	%
Vehicular Access from lane or lower classed road?	Yes	(y/n)	Lane Access	(y/n)
Principal Uses	Secondary Uses			
Development Regulations	Zone Requireme	nt	Proposal	
Total Number of Units			4 Units	
Floor Area (gross/net)	464.6	m	431.8	m
Building(s) Setbacks (east/west/north/south):				
Front <u>South</u>	4.0	m	4.0	m
Side <u>East</u> Flanking Street	4.0	m	2.0 / 4.0 (Variance Req'd)	m
Side <u>West</u>	1.2	m	1.2	m
Rear North	0.9	m	0.9	m
Rear setback to accessory buildings	0.9	m	0.9	m
Building step back		m		m
Min. Separation Distance between buildings		m		m
Maximum Continuous Building Frontage		m		m

Density and Height Regulations (13.6, 14.4)	Zone Requirement	Proposal
Minimum Density (Transit Corridor Only)		
Floor Area Ratio (FAR):		
Base FAR	.8	.8
Streetscape Bonus		
Rental/Affordable Bonus		
Building Height (storeys/metres):		
OCP Map Designated Height	8 m/ storeys	7.2 m/ 2 storeys
Maximum Streetscape Bonus Height	m/ storeys	m / storeys
Amenity Space (13.5, 14.11, 14.13)	Zone Requirement	Proposal
Total Common Amenity Area	m²	m²
Total Private Amenity Area	m²	m ²
Breakdown by Unit Bachelor: 1-Bed: 2-Bed: 3-Bed:		
Landscaping Standards (7.2)	Zone	Proposed
Min. tree amount	1 per 10 linear meter	8 per 10 linear meter
Min. deciduous tree caliper	4 cm	6 cm
Min. coniferous tree height	N/A cm	N/A cm
Min. ratio between tree size	No min or max %	No min or max
Min. growing medium area	75 %	76 %
Min. growing medium volumes per tree	18 cu m m³	19% m³
Landscape graded areas (7.2.7)	%	%
Fence Height	2 m	1.83 m
Riparian management area?	(y/n) N
Retention of existing trees on site?	(y/n) N
Surface parking lot (7.2.10)?	(y/n) N
Refuse & recycle bins screened?	(y/n) N
Other:		

n	ın	•	Δ	c	

Zoning Bylaw No. 12375, Kelowna 2040 OCP Bylaw No. 12300

Parking Regulations (Section 8.3)

Parking Regulations 8.3:	Zone Requirement	Proposal
Total Stalls Required:	1 parking space per dwelling (8.3.1.4)	4
Bachelor		
1-Bed		
2-Bed		
3-Bed		
Visitor Stalls		
Rental Reduction		
Car Share Reduction		
Bonus Bike Parking Reduction		
Accessible Stalls		
Van Accessible Stalls		
Other Uses:		
Ratio of Parking Stalls	% Regular % Small	% Regular % Small
Drive Aisle Width	m	m
Drive Aisle Grade	%	%
Loading Stalls (Section 8.4)		
Bicycle Parking Regulations 8.5:	Zone Requirement	Proposal
Total Stalls Required (Required or Bonus):	4	4 long term - Garage Storage
Bachelor		3 3
1-Bed		
2-Bed		
3-Bed		
Short Term		
(within 15m of entrance)		
Other Uses:		
End of Trip Facility?	No (y/n)	(y/n)
Bike Wash and Repair Station?	No (y/n)	(y/n)

Notes

Specific Built Form Regulations

Ground Oriented Regulations (footnotes)	Zone Requirement	Proposal
Reduced setback	m	m
Maximum first floor height	m	m
Minimum Floor Area on First Floor	m ²	m²
Urban & Village Centre Regulations (14.11)	Zone Requirement	Proposal
Upper Floor Setbacks abutting street	m	m
Corner Lot Triangular Setback	m	m
Urban Plaza	(y/n) m²	(y/n) m²
Street Type:		
Max/Min Commercial		
Max/Min Residential		
Max Site Coverage based on Street Type	%	%
Max Parkade Exposure	%	%
Tall Building Regulations (9.11)	Regulation	Proposed
Min. amount of transparency on 1st floor	75% Commercial Frontage	%
Min. depth of commercial unit fronting street	6 m	m
Triangular Setback	4.5 m	m
Max. Podium Height	16.0 m / 4 storeys	m / storeys
Podium Rooftop	No open parking	
Building Separation	60 m	m
Maximum Floor Plate GFA:		
Residential	750 m²	m²
Hotel	850 m²	m²
Office/Commercial	930 m²	m²
Tower Stepback	3 m	m
Barrier free accessibility	Main Residential entrance and all commercial entrances	(y/n)
Other		

Notes: